
EXISTING LOCATION PLAN

0 1

EXISTING SITE PLAN

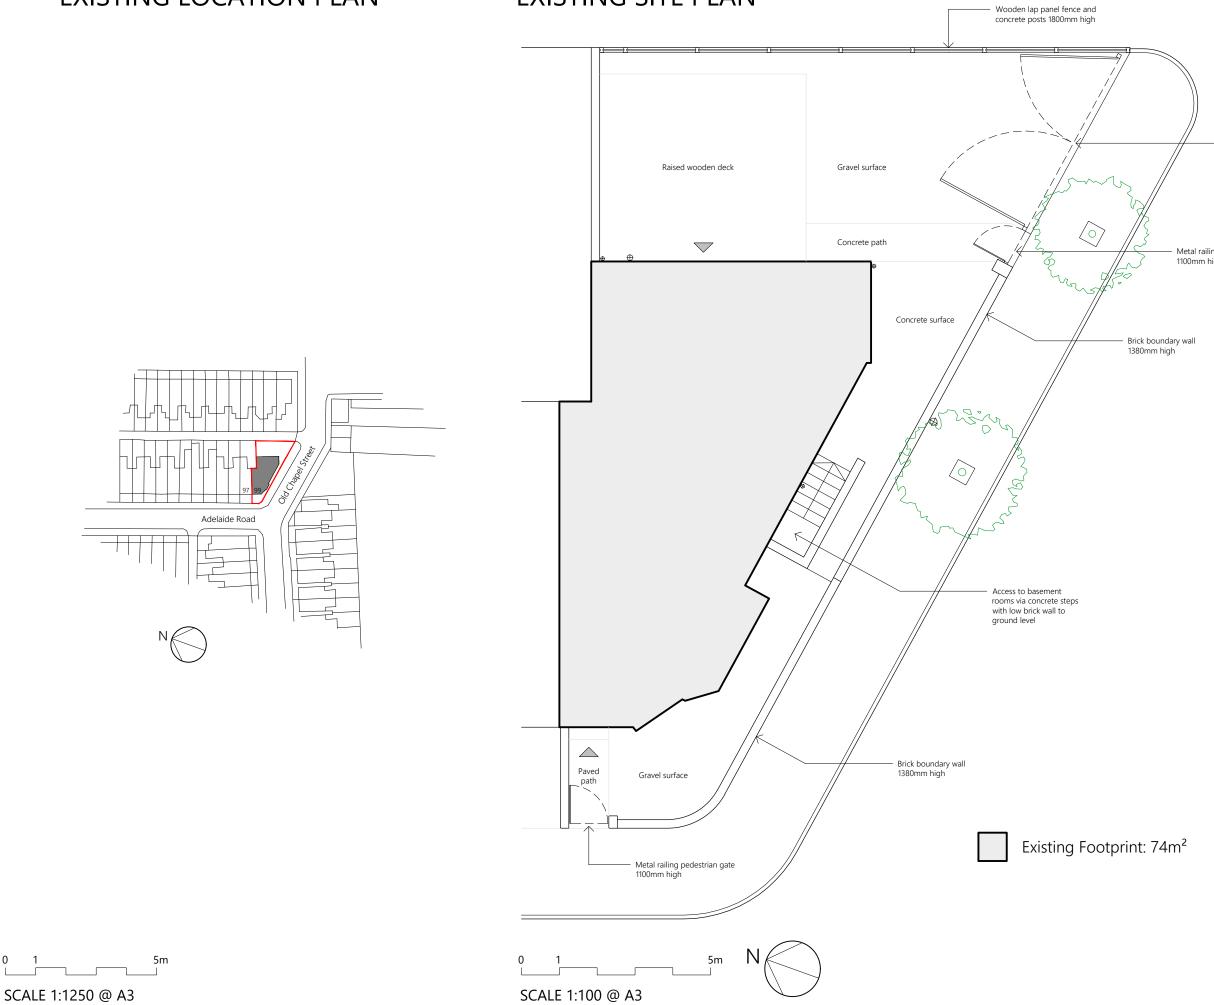

Disclaimer

Bramhall Town Planning Limited accepts no responsibility for any costs, losses or claims whatsoever arising from these drawings, specifications and related documents unless there is full compliance with the client or any unauthorised user of the following:

All boundaries, dimensions and levels are to be checked on site before construction and any discrepancies reported to the Architect / Designer.

For the purpose of coordination, all relevant parties must check this information prior to implementation and report any discrepancies to the Architect / Designer.

Plans not to be scaled from for construction

©Copyright 2024

Metal railing gates 1100mm high


Metal railing pedestrian gate 1100mm high

levision	Date

_

_

99 Adelaide Road, Stockport		
Drawing Existing Location Plan / Site Plan		
Purpose Planning	Date 2024-11-19	Scale As noted
Drawing Number BTP-99AR-S	SP-001	Revision

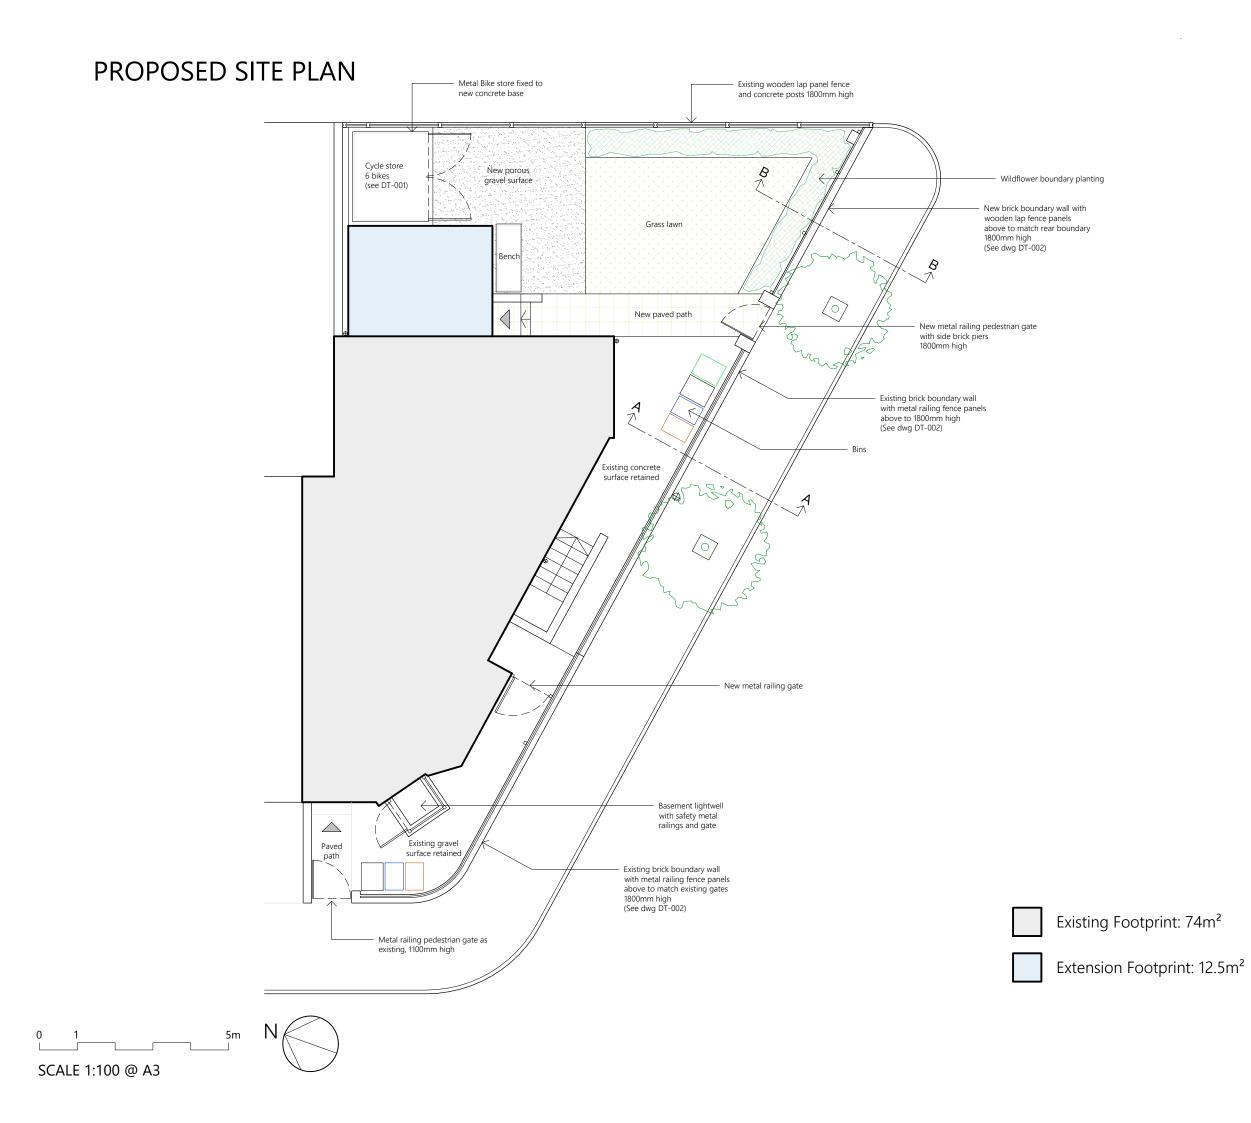

Bramhall Town Planning Limited accepts no responsibility for any costs, losses or claims whatsoever arising from these drawings, specifications and related documents unless there is full compliance with the client or any unauthorised user of the following:

All boundaries, dimensions and levels are to be checked on site before construction and any discrepancies reported to the Architect / Designer.

For the purpose of coordination, all relevant parties must check this information prior to implementation and report any discrepancies to the Architect / Designer.

Plans not to be scaled from for construction

©Copyright 2024

RevisionDate12024-12-17Cycle store size increased.

99 Adelaide Road, Stockport		
Drawing Proposed S	Site Plan	
Purpose	Date	Scale
Planning	2024-11-19	1:100 @ A
		Revision
Drawing Number		

WEST ELEVATION

SOUTH ELEVATION





EAST ELEVATION



5m

0 SCALE 1:100 @ A3

Disclaimer

Bramhall Town Planning Limited accepts no responsibility for any costs, losses or claims whatsoever arising from these drawings, specifications and related documents unless there is full compliance with the client or any unauthorised user of the following:

All boundaries, dimensions and levels are to be checked on site before construction and any discrepancies reported to the Architect / Designer.

For the purpose of coordination, all relevant parties must check this information prior to implementation and report any discrepancies to the Architect / Designer.


BRAMHALL TOWN PLANNING

Date


_

Project 99 Adelaide Road, Stockport		
Existing Elevations		
Purpose	Date	Scale
Planning	2024-11-19	1:100 @ A3
Drawing Number		Revision
BTP-99AR-EL-001		-


WEST ELEVATION

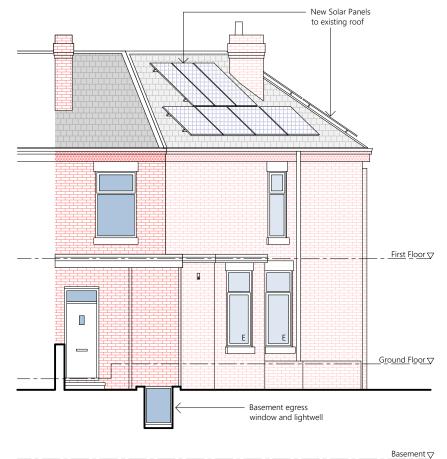


SOUTH ELEVATION

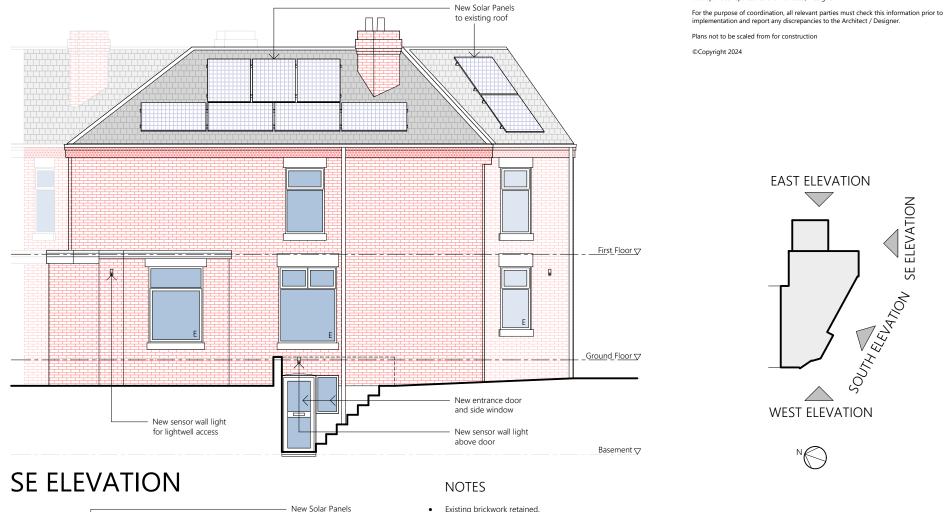

EAST ELEVATION

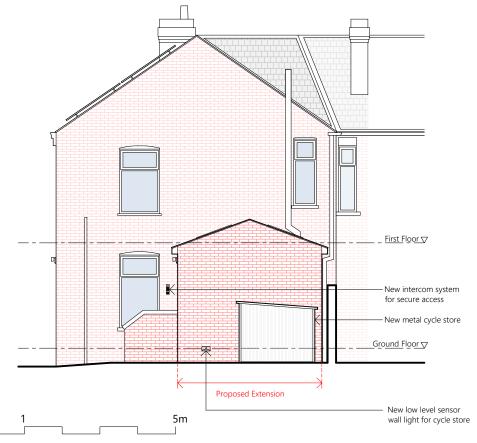

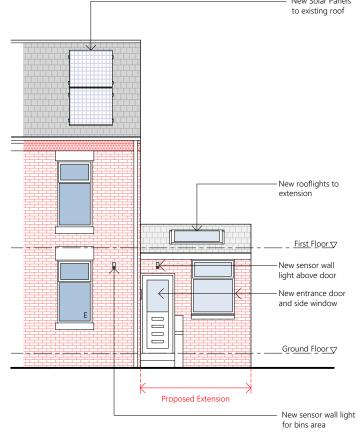

- Existing brickwork retained.
- Extension brickwork to match existing.
- All windows and doors to be white UPVC to match existing. • Window specification as per Noise
- Impact Assessment. • Windows to ground floor bedrooms to
- be replaced with escape windows (E).
- Extension roof to match existing house. • Extension rooflights to be anthracite
 - grey.
- New lights to be PIR motion sensor to IP65 rating

Disclaimer

Bramhall Town Planning Limited accepts no responsibility for any costs, losses or claims whatsoever arising from these drawings, specifications and related documents unless there is full compliance with the client or any unauthorised user of the following:


All boundaries, dimensions and levels are to be checked on site before construction and any discrepancies reported to the Architect / Designer.


Revision	Date
1	2025-01-08
New lia	hting and intercom system added to elevations


99 Adelaide Road, Stockport			
Proposed Elevations			
Purpose Planning	Date 2024-11-19	^{Scale} 1:100 @ A3	
Drawing Number BTP-99AR-EL-002		Revision 1	

BASEMENT

GROUND FLOOR

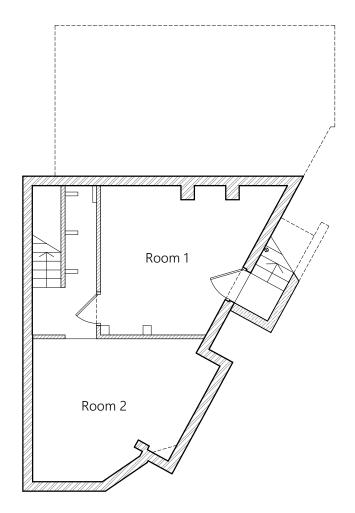

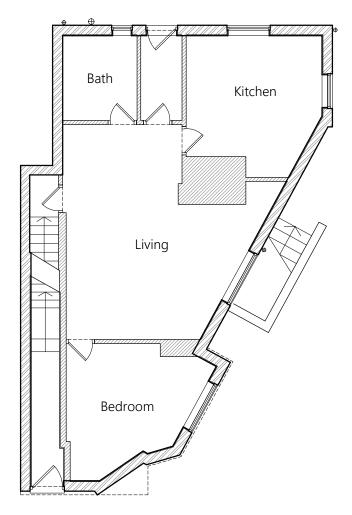

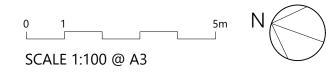

Bramhall Town Planning Limited accepts no responsibility for any costs, losses or claims whatsoever arising from these drawings, specifications and related documents unless there is full compliance with the client or any unauthorised user of the following:

All boundaries, dimensions and levels are to be checked on site before construction and any discrepancies reported to the Architect / Designer.

For the purpose of coordination, all relevant parties must check this information prior to implementation and report any discrepancies to the Architect / Designer.

Plans not to be scaled from for construction

©Copyright 2024


BRAMHALL TOWN PLANNING

Date


_

99 Adelaide Road, Stockport			
Drawing Existing Grou	und Floor & Ba	asement Plans	
Purpose	Date	Scale	
Planning	2024-11-19	1:100 @ A3	
Drawing Number		Revision	
BTP-99AR-PI	001	-	

BASEMENT

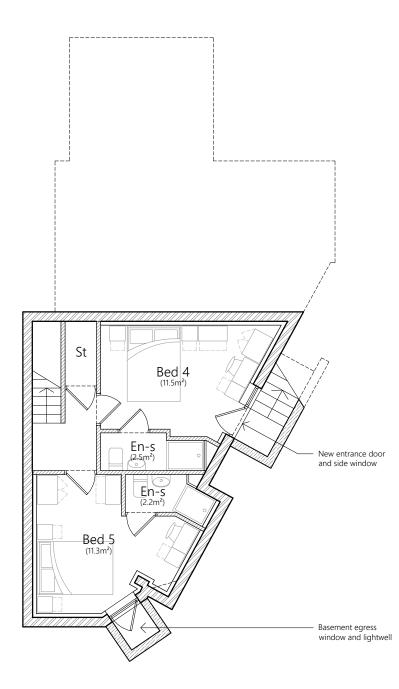

GROUND FLOOR

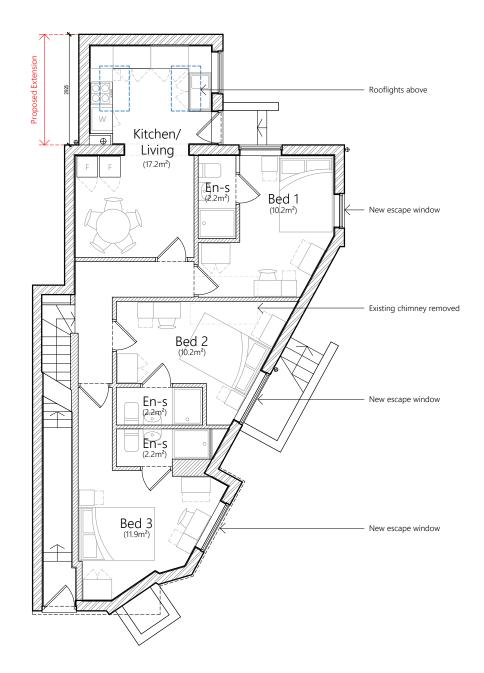

0 1 5m N SCALE 1:100 @ A3

Bramhall Town Planning Limited accepts no responsibility for any costs, losses or claims whatsoever arising from these drawings, specifications and related documents unless there is full compliance with the client or any unauthorised user of the following:

All boundaries, dimensions and levels are to be checked on site before construction and any discrepancies reported to the Architect / Designer.

For the purpose of coordination, all relevant parties must check this information prior to implementation and report any discrepancies to the Architect / Designer.

Plans not to be scaled from for construction

©Copyright 2024

BRAMHALL TOWN PLANNING


Date


_

99 Adelaide Road, Stockport			
Drawing Proposed Ground Floor & Basement Plans			
Purpose	Date	Scale	
Planning	2024-11-19	1:100 @ A3	
Drawing Number		Revision	
BTP-99AR-PL	-002	-	

EXISTING

PROPOSED

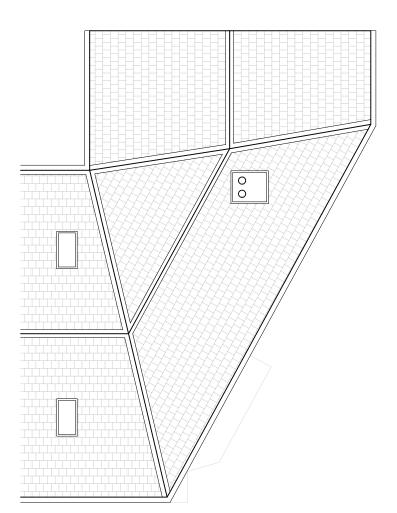

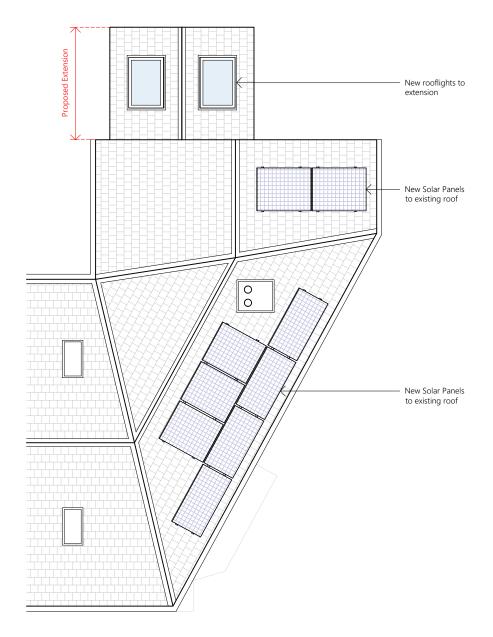

0 1 5m N SCALE 1:100 @ A3

Bramhall Town Planning Limited accepts no responsibility for any costs, losses or claims whatsoever arising from these drawings, specifications and related documents unless there is full compliance with the client or any unauthorised user of the following:

All boundaries, dimensions and levels are to be checked on site before construction and any discrepancies reported to the Architect / Designer.

For the purpose of coordination, all relevant parties must check this information prior to implementation and report any discrepancies to the Architect / Designer.

Plans not to be scaled from for construction

©Copyright 2024

BRAMHALL TOWN PLANNING


Date

_

99 Adelaide Road, Stockport			
Drawing Existing & Proposed Roof Plans			
Purpose	Date	Scale	
Purpose Planning	Date 2024-11-19		

BOUNDARY WALL / FENCE

SECTION A-A 1:50

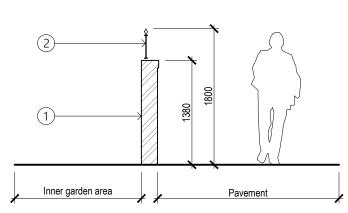

NOTES

- 1. Existing 1380mm high brickwork boundary wall retained.
- 2. Metal railing panels bolted to brick wall to 1800mm high.




STREET ELEVATION

STREET ELEVATION

1:50


800

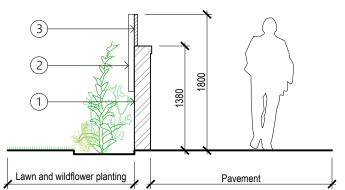


NOTES

- New 1380mm high brickwork boundary wall to match existing boundary brickwork wall.
- 2. Wooden support posts bolted to brick wall.
- Wooden lap fence panels to match existing rear boundary fence to 1800mm high. Panels fixed to support posts.

0 1 5m

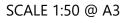

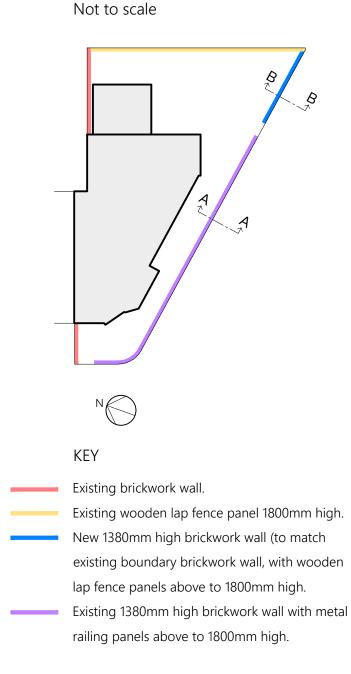

KEY SITE PLAN

Bramhall Town Planning Limited accepts no responsibility for any costs, losses or claims whatsoever arising from these drawings, specifications and related documents unless there is full compliance with the client or any unauthorised user of the following:

All boundaries, dimensions and levels are to be checked on site before construction and any discrepancies reported to the Architect / Designer.

For the purpose of coordination, all relevant parties must check this information prior to implementation and report any discrepancies to the Architect / Designer.

Plans not to be scaled from for construction

©Copyright 2024

BRAMHALL TOWN PLANNING

Date


Revision

Drojost

99 Adelaide Road, Stockport			
Drawing Boundary Wall Details			
Purpose Planning	Date 2024-11-19	^{Scale} 1:50 @ A3	
Drawing Number BTP-99AR-1	DT-002	Revision	

CYCLE STORE



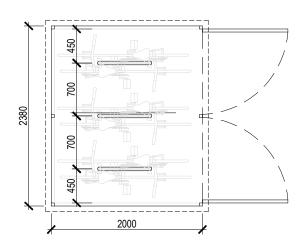




PHOTO


PHOTO



SIDE ELEVATIONS

FRONT ELEVATION

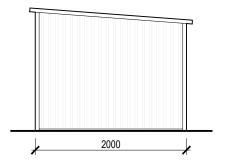


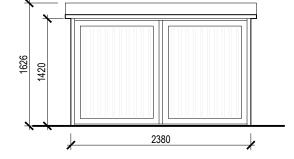

NOTES

- Galvanized steel frame
- Galvanized corrugated steel cladding panels with tough epoxy resin coating inside and out.
- Double hinged doors with key locking bolts top and bottom.
- Galvanized steel foundation rails bolted to concrete floor.
- Photo illustrative only, bike store will be of similar appearance but with dimensions as noted above.

CYCLE STORE SECTION

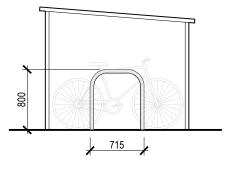

NOTES

- 3no. Sheffield cycle stands (Broxap)
- 48mm dia tube frame
- Hot dip galvanized to BS EN ISO 1461
- Baseplate bolted to concrete floor


Bramhall Town Planning Limited accepts no responsibility for any costs, losses or claims whatsoever arising from these drawings, specifications and related documents unless there is full compliance with the client or any unauthorised user of the following:

All boundaries, dimensions and levels are to be checked on site before construction and any discrepancies reported to the Architect / Designer.

For the purpose of coordination, all relevant parties must check this information prior to implementation and report any discrepancies to the Architect / Designer.

Plans not to be scaled from for construction

©Copyright 2024

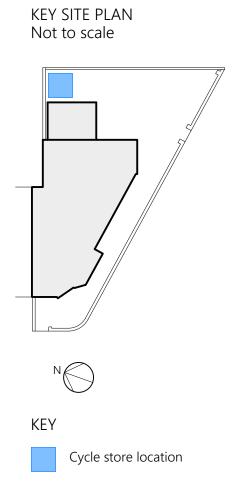

Revision Date 2024-12-17

Cycle store size increased, Sheffield stands added to interior.

99 Adelaide Road, Stockport			
Cycle Store Details			
Purpose	Date	Scale	
Planning	2024-11-19	1:50 @ A3	
Drawing Number		Revision	
BTP-99AR-DT-001		1	