

All dimensions and building footprints are taken from OS Map data and are subject to the accuracy of this

> A PEDESTRIAN ACCESS AND PAVED/
> LANDSCAPING AREAS AMENDED, TO FRONT/
> EAST SIDE OF CHURCH. RAMP TO PLAY
> AREA REMOVED. 16.05.24 PS MT Date By Chk Rev Description

Purpose for Issue Planning Tender PLANNING

Construction As Built PLANNING

ST. MARTINS C. OF E. CHURCH **HEATON NORRIS** 

PROPOSED REMODELLING AND EXTENSION

bateandtaylor architects

macintosh house 4a cambridge street


manchester m1 5gg tel: 0161 236 0999 fax: 0161 236 0404 mail@bate-taylor.co.uk


Drawing No. MH1274-P17 Revision A 1:200 @ A1 Date FEB '24 MDM

Checked MT





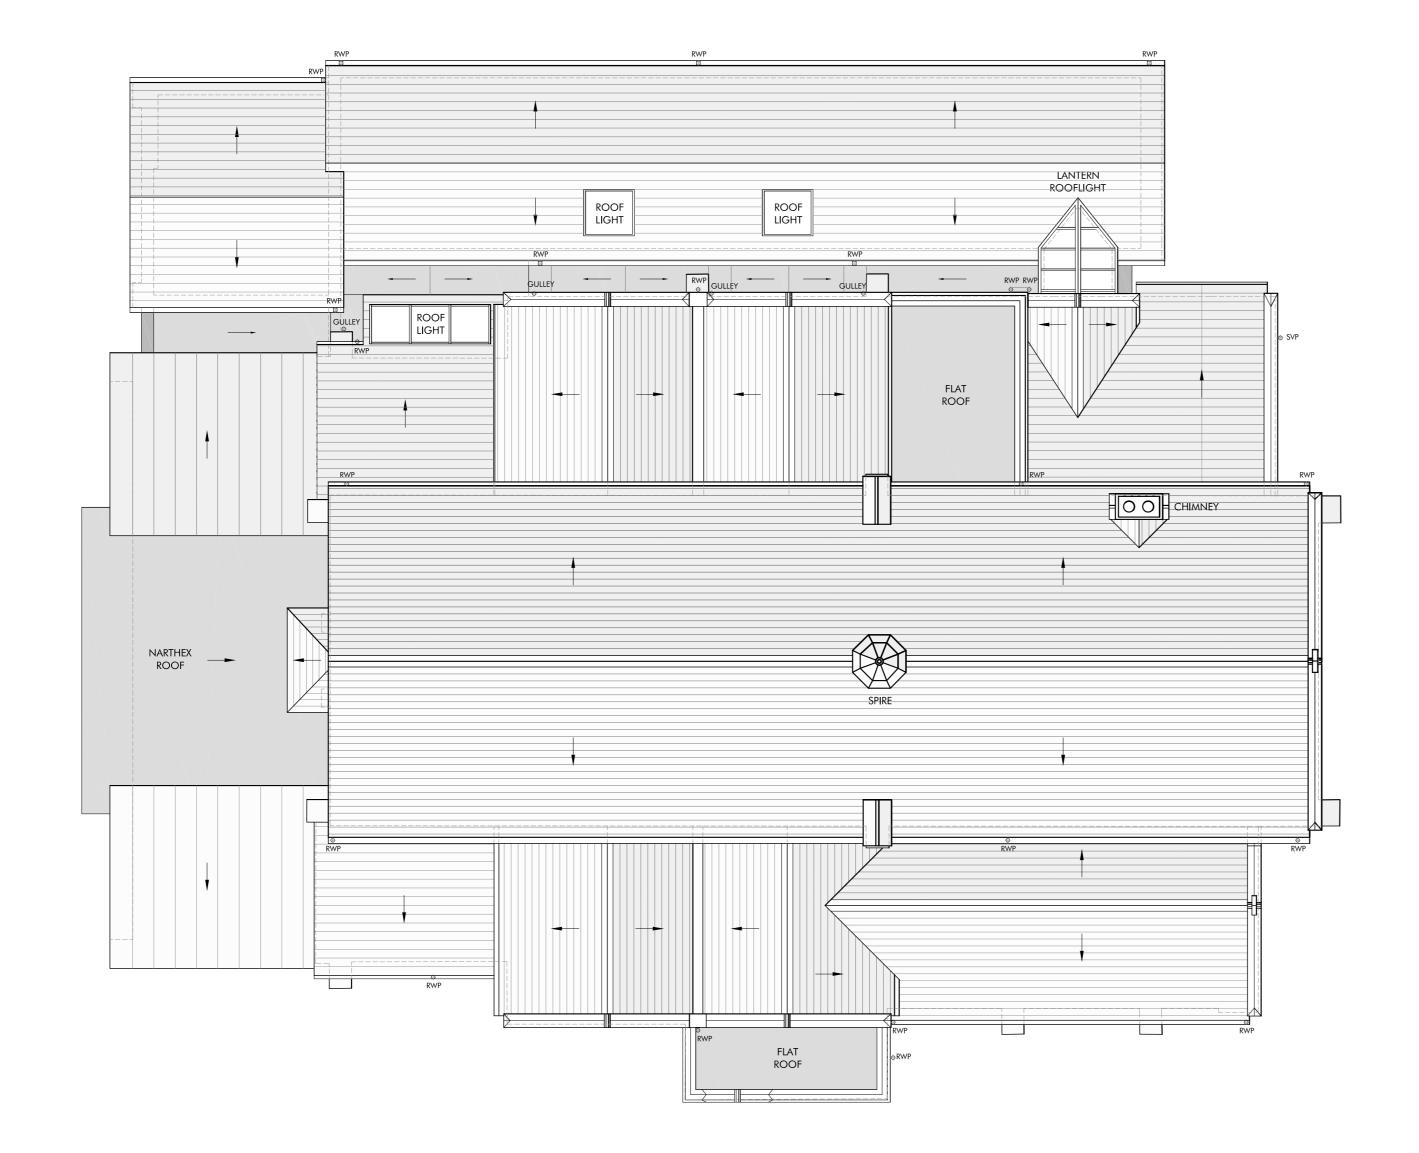

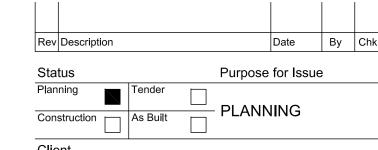

ST. MARTIN'S C. OF E. CHURCH **HEATON NORRIS** 

Contract

PROPOSED REMODELLING AND EXTENSION

Drawing

PROPOSED ROOF PLAN



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Drawing No. MH1274-P11 Revision /

MDM

Drawn

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1:100 @ A2 Date FEB '24 Checked MT

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O1 Proposed Roof Plan
Scale 1:100 @ A2





# Proposed South Elevation Scale 1:100 @ A1



Proposed East Elevation
Scale 1:100 @ A1

A	A RAMP TO PLAY AREA REMOVED.		16.05.24	PS	MT	
Rev	Description		Date	Ву	Chk	
Status Purpose for Issue						
Planning Tender  Construction As Built PLANNING						
	nt MARTINS C. OF E. C ATON NORRIS	HURCH	ł			
Con	tract OPOSED REMODELL	ING AN	D EXTI	ENS	IO	

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PROPOSED ELEVATIONS 1

(SOUTH AND EAST ELEVATIONS)

Drawing

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1:100 @ A1 Date FEB '24



# Proposed North Elevation Scale 1:100 @ A1



Proposed West Elevation
Scale 1:100 @ A1



B HICH LEVEL WINDOWS OBSCURELY GLAZED
TO LOBBY AND CHILDRENS MINISTRY 1
A RAMP TO PLAY AREA REMOVED.

Rev Description
Date
By Chk

Status
Planning
Tender
Construction
As Built
PLANNING

Client

ST. MARTINS C. OF E. CHURCH HEATON NORRIS


Contract
PROPOSED REMODELLING AND EXTENSION

Drawing
PROPOSED ELEVATIONS 2
(NORTH AND WEST ELEVATIONS)

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Drawing No. MH1274-P13 Revision B
Scales 1:100 @ A1 Date FEB '24
Drawn MDM Checked MT




CHANCEL FOOD BANKY CHILDREN'S MINISTRY 1

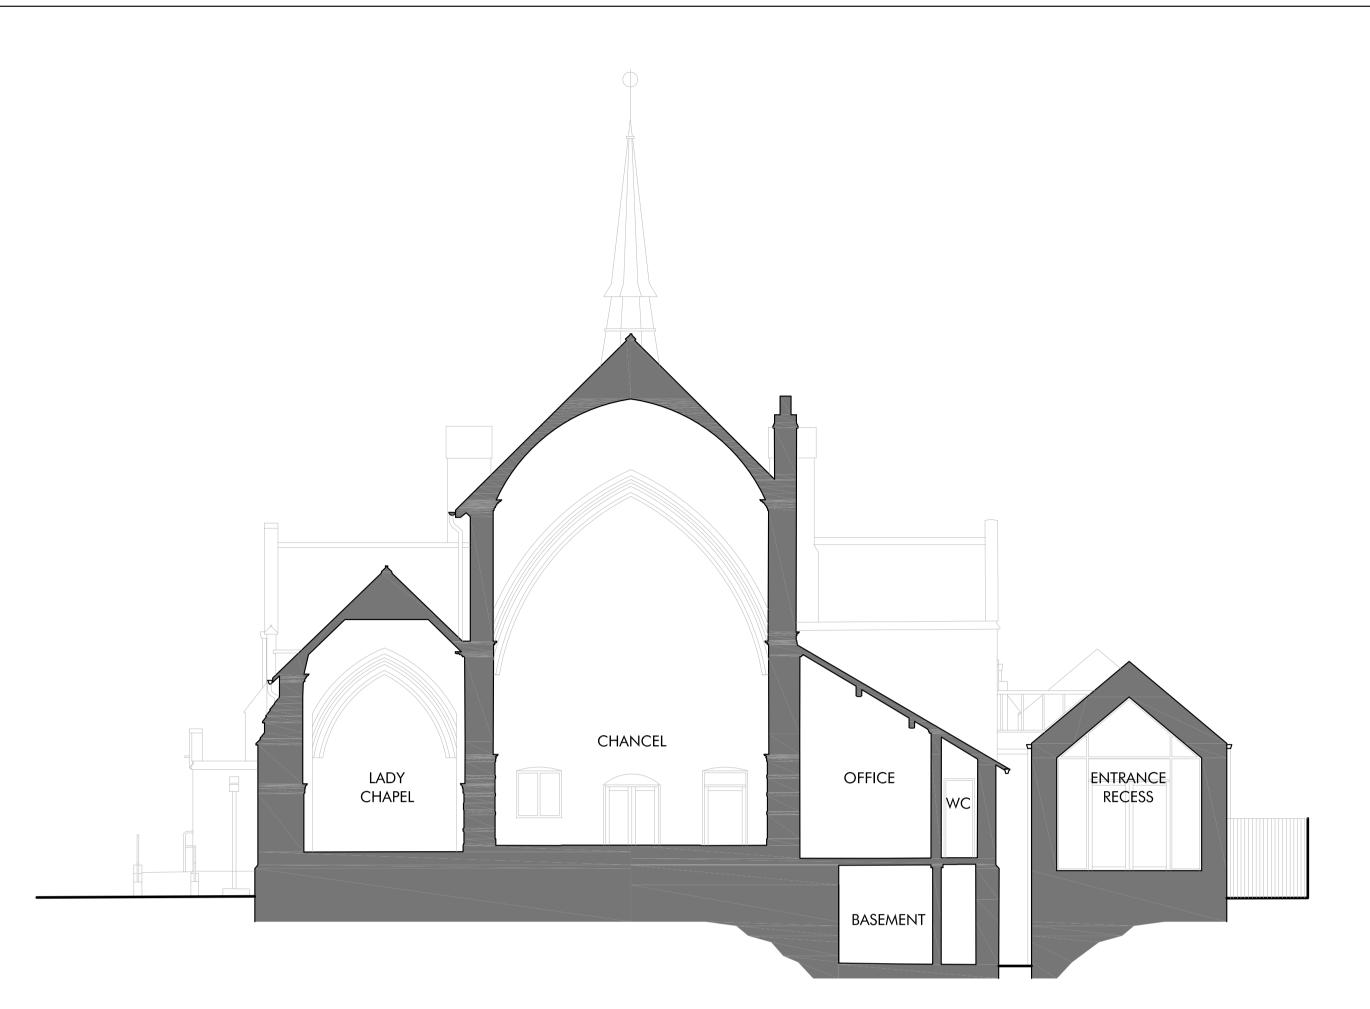Proposed Section A:A

Scale 1:100 @ A1


Proposed Section B:B

Scale 1:100 @ A1

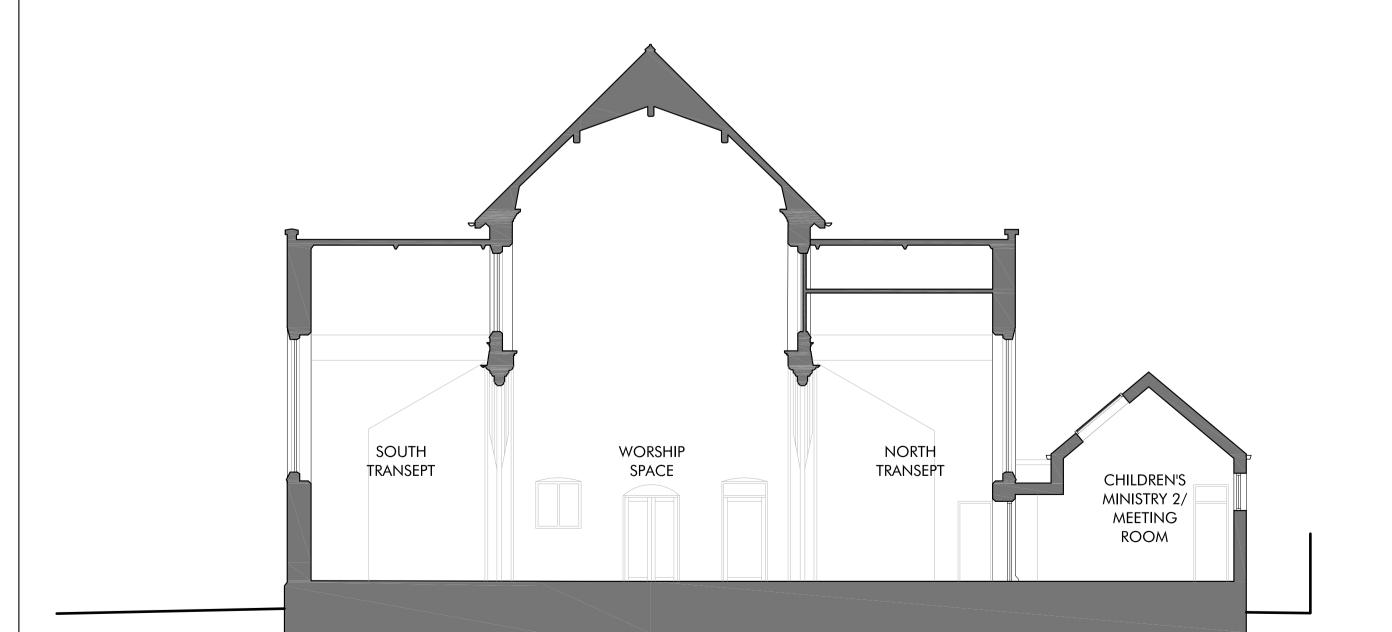

Proposed Section C:C


Scale 1:100 @ A1

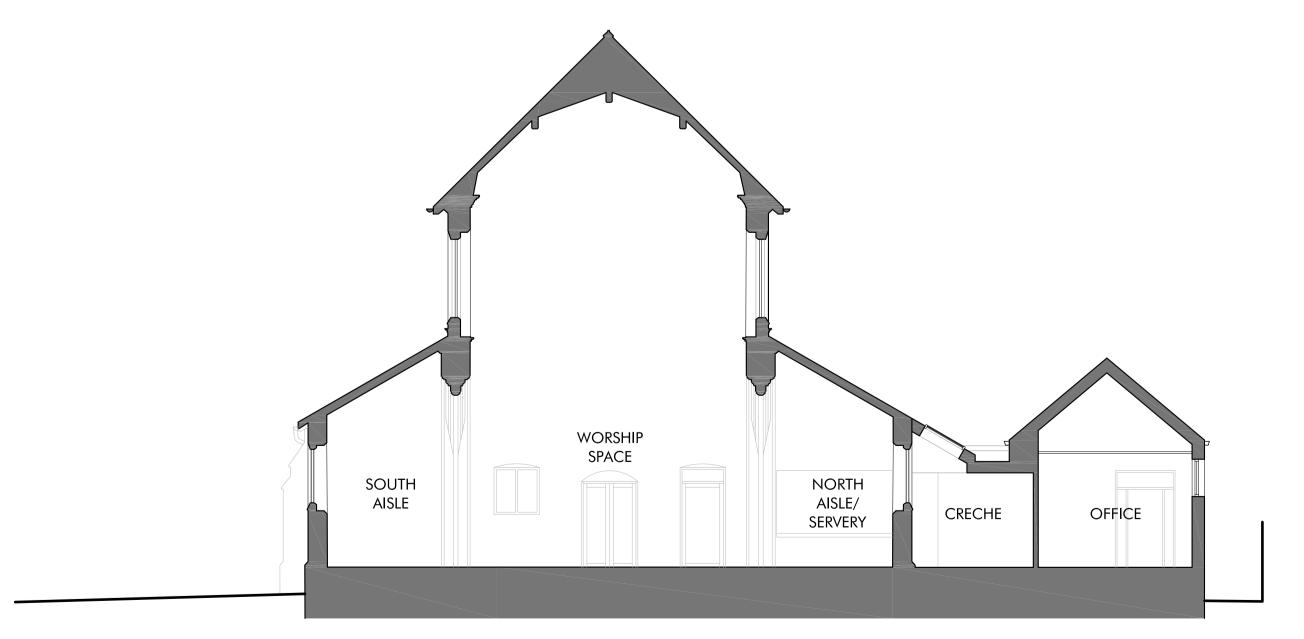

Proposed Section D:D

Scale 1:100 @ A1



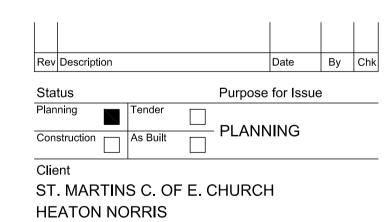

Contract
PROPOSED REMODELLING AND EXTENSION

Drawing
PROPOSED SECTIONS 1
SECTIONS A:A, B:B, C:C & D:D




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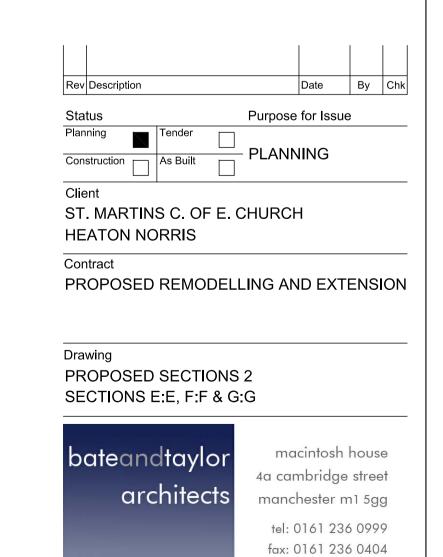
Proposed Section E:E

Scale 1:100 @ A1



KITCHEN WC LOBBY NARTHEX

Proposed Section F:F
Scale 1:100 @ A1

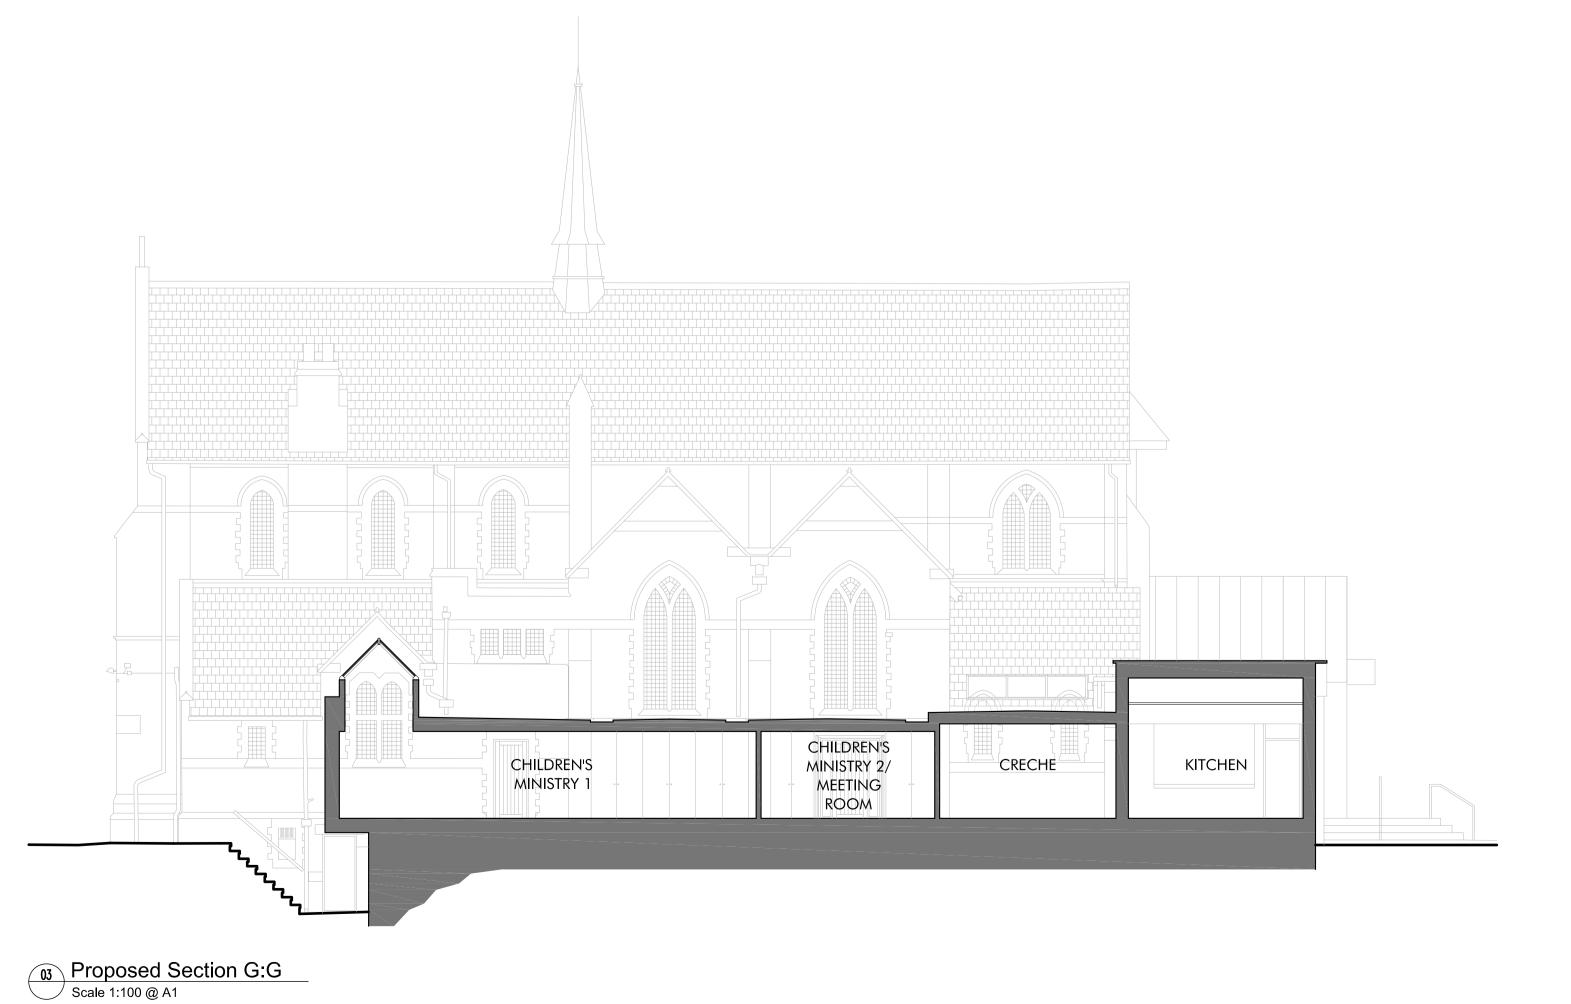

Drawing No. MH1274-P15 Revision /

1:100 @ A1 Date FEB '24

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m 0 1 2 3 4 5 6 7 8 9 10 SCALE 1:100




Proposed Street Scene - East Elevation (Crescent Park)

Scale 1:100 @ A1



Proposed Street Scene - South Elevation (Didsbury Road)
Scale 1:100 @ A1



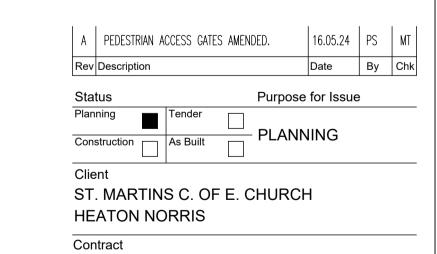

PROPOSED REMODELLING AND EXTENSION

Drawing
PROPOSED STREET SCENE
EAST AND SOUTH ELEVATION



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ales 1:100 @ A1 Date FEB '24
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TREES										
Species		Size/Type	Height (cm	Girth (cm)	Specification	Number				
					Heavy					
Вр	Betual pendula	RB	350-400	12-14cm	Standard	3				
PaP	Prunus avium 'Plena'	RB	350-400	12-14cm	Heavy	5				
					Heavy					
Sa	Sorbus aria	RB	350-400	12-14cm	Standard	3				

Area

66.5

ease do not substitute any of the plants listed above for smaller specimens or other species unless agreed with the client or ındscape architect. Contractor to calculate plant numbers and ensure all are correct before ordering.

#### PLANTING NOTES:

GRASS SEEDED AREAS (TOTAL AREA: 1330m2)

WFG20 Eco Species Rich Lawn

Tree procurement, planting and management shall be in accordance with BS 8545:2014 Trees: from Nursery to dependence in the landscape- Recommendations. All other plants shall be handled in accordance with 'Plant Handling', the booklet published by the Committee for Plant Supply and Establishment (CPSE). The contractor shall comply with clauses 3 & 4 of the above booklet (obtained from the Horticulture Trades Association, 19 High Street, Theale, Reading, Berks RG7 5H) which refers to the receipt, unloading and temporary storage of plants.

Plants shall be first class examples of their species or variety, free from all pests and diseases, with good fibrous root systems and materially undamaged (refer to relevant sections of BS3936 Parts 1-4 'Specification of Nursery Stock').

. All planting is to be in general compliance with BS4428: 1989 'Code of Practice for general landscape operations

#### Tree Planting:

Trees should be planted in pits  $750 \times 750 \times 750$ mm deep and base broken out to facilitate drainage. A peat free compost and slow release tree fertiliser should be incorporated into the back fill material. A Root Rain Metro irrigation pipe should be fitted around the rootball and fixed into place above ground level. Trees to be secured with double timber stakes and timber cross bar with a rubber tree tie.

### . Shrub Beds and Planting General:

i) All beds should be free draining and free from builders rubble and large stones. There should be min 450mm of good quality top soil to all the shrubs beds (which is expected to be supplied by the house builder). ii) Areas to be treated with a non-residual glyphosate based herbicide prior to planting and cultivated to a depth of

iii) A slow release fertiliser mixed with a peat free compost should be incorporate into the back fill material when planting the shrubs to give them the best possible chance of establishment.

iv.) For hedges dig a trench the full length of the hedge 500mm wide x 400mm deep and break up the base to facilitate

iv)Setting out to be agreed with Landscape Architect prior to planting

#### Finishing Beds:

i) The finished surface of the bed should be free from weeds, stones or rubble and the surface of the soil cultivated to level out any clumps, mounds or depressions.

ii) When planted all shrub beds are to be mulched with 50mm depth of small grade bark mulch. iii) The beds should be maintained weed free and the beds topped up annually with bark mulch as required.

### i) Beds should be free draining and free from builders rubble and large stones. There should be min 150mm of good

quality top soil to all the areas to be turfed (which is expected to be supplied by the house builder). i) Areas to be cultivated to a depth of 150mm and finished to a fine tilth with smooth even contours and gradients. ii) Prior to laying turf the areas should be sprayed with a non-residual glyphoshate based herbicide. v) Ensure that the grass is maintained to 25-50mm and once established mown min 12 times a year in the growing

Water all plants and trees on the same day of planting and thereafter as necessary (min once/week) in periods of drought to ensure the establishment of the plants during the 12 months defects period.

#### All shrub beds to be maintained weed free by regularly hand weeding the beds and spot treating any prolific weeds with

a glyphosate based weed killer. Maintaining the bark mulch will also help to reduce weed growth.

10. The contractor must ascertain himself/herself of the exact location of underground services prior to carrying out any digging on site.

The landscaping works shall be carried out in accordance with the approved scheme within the first planting season ollowing the completion of construction works.

2. Any trees or shrubs which are removed, uprooted, destroyed, die or become severely damaged or become seriously diseased within 5 years of planting shall be replaced within the next planting season by trees or shrubs of similar size and species to those originally required to be planted.

#### SOFT LANDSCAPE



Existing Trees to be retained with RPA Please refer to the Arboricultural Impacts Assessment for further information on all proposed tree works and tree protection measures.




**Existing vegetation** Please refer to the Arboricultural Impacts Assessment for further information on all proposed tree works and tree protection measures.



Proposed feature species trees Planted as standard 16-18cm girth



Proposed ornamental shade mix Planted as 60-80cm high BR at I per sq.m in single

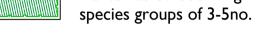

**Proposed Ornamental Shrub Beds with specimen** To be planted as 3L pots at 3-5 per sq.m with 15-25L

specimens, beds to be mulched with medium grade bark



**Proposed Mixed Native Hedge** Planted as 100-120 BR planted at 6 per lin.m in a double



47

g

6650

Density

10g/m2

staggered row. Proposed species rich grassland - Public Open



To be seeded with WFG20 Eco Species Rich Lawn from Germinal sown at 10g per sq.m

Rev D: Existing hedge shown as retained. Rev C: Trees species changed.

Rev B: Trees added. Rev A: Existing tree survey added.

31-08-2023 (TR) 17-08-2023 (TP)

23-05-2024 (TR)

25-09-2023 (TR)



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St. Martins Church

**Project** 

Stretton Court, Hinckley

Description

Landscape Layout

Status

Scale

Drawn 1:200@A1

lob number Drawing number

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All levels and dimensions to be checked on site by contractor prior to commencement; Any variations to be reported to the client. This drawing is to be read in conjunction with all others relating to the project and all information derived accordingly; any anomalies to be reported to the client. Do not scale from this drawing. Use figured dimensions only. Work shown on this drawings to be carried out in accordance with current British Standards and Codes of Practice.

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