




LOCATION PLAN: Scale: 1:1250

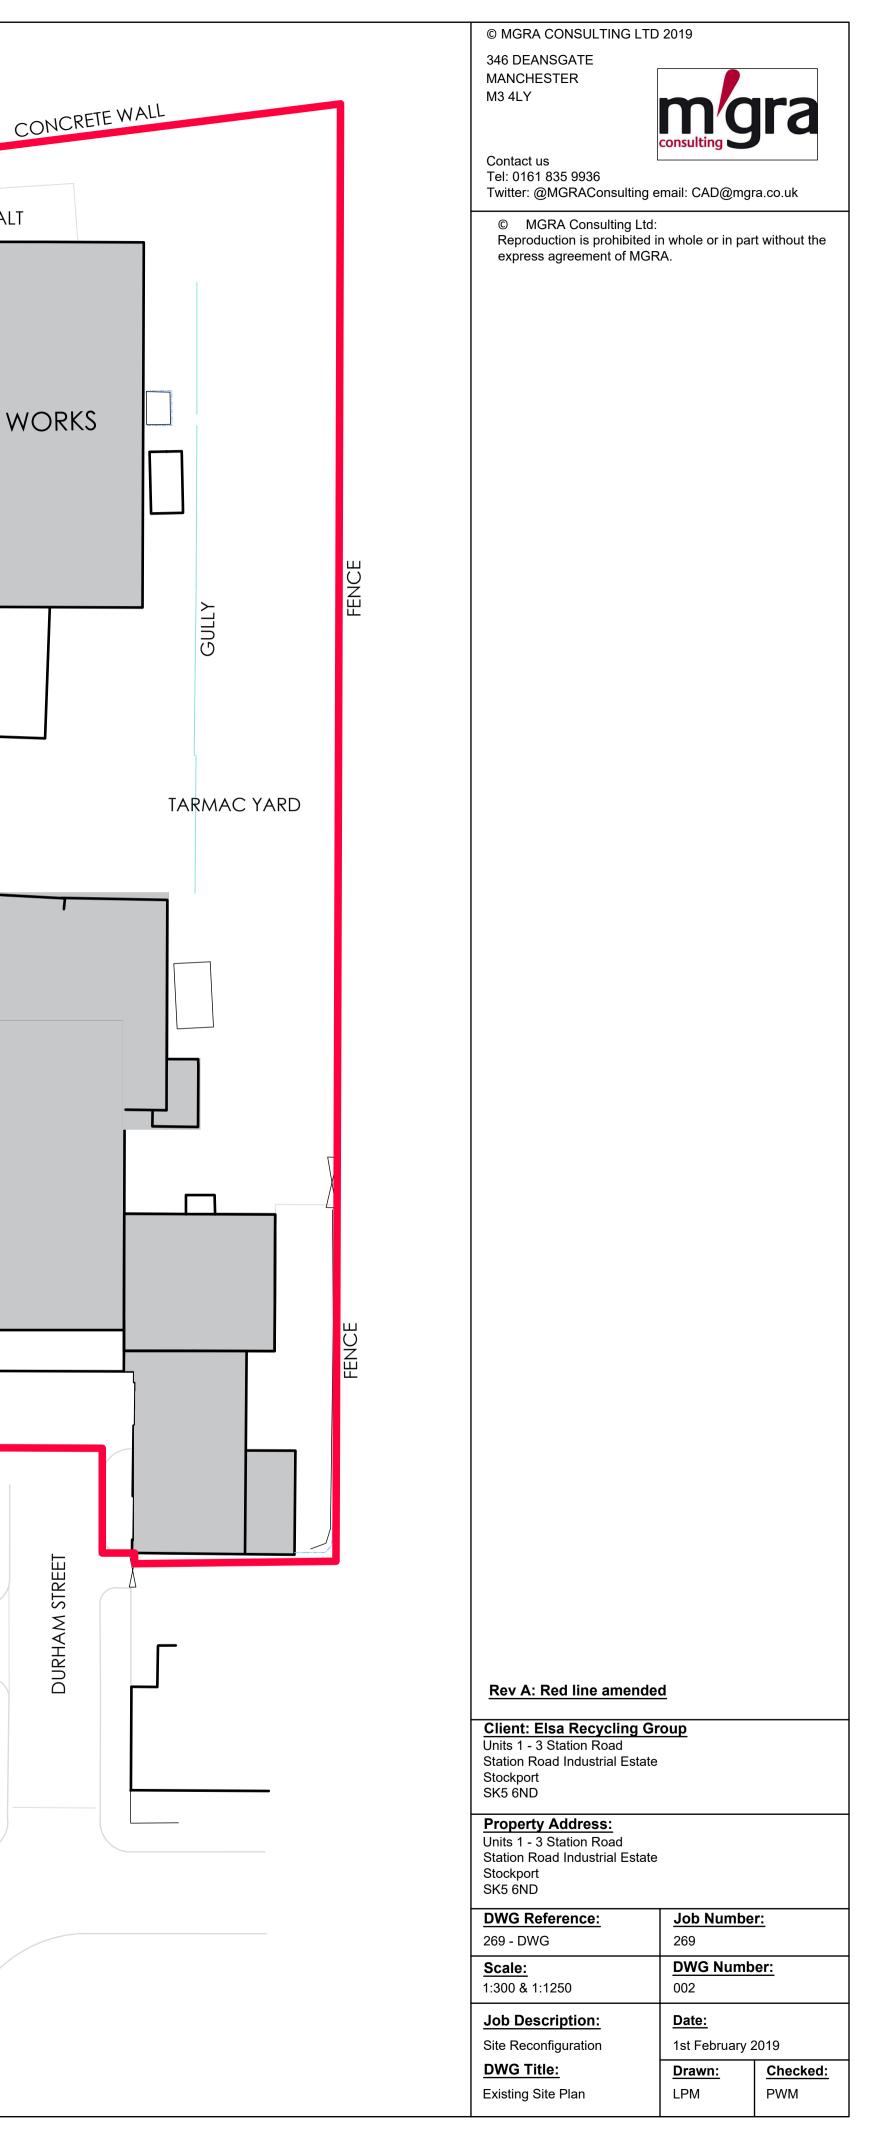

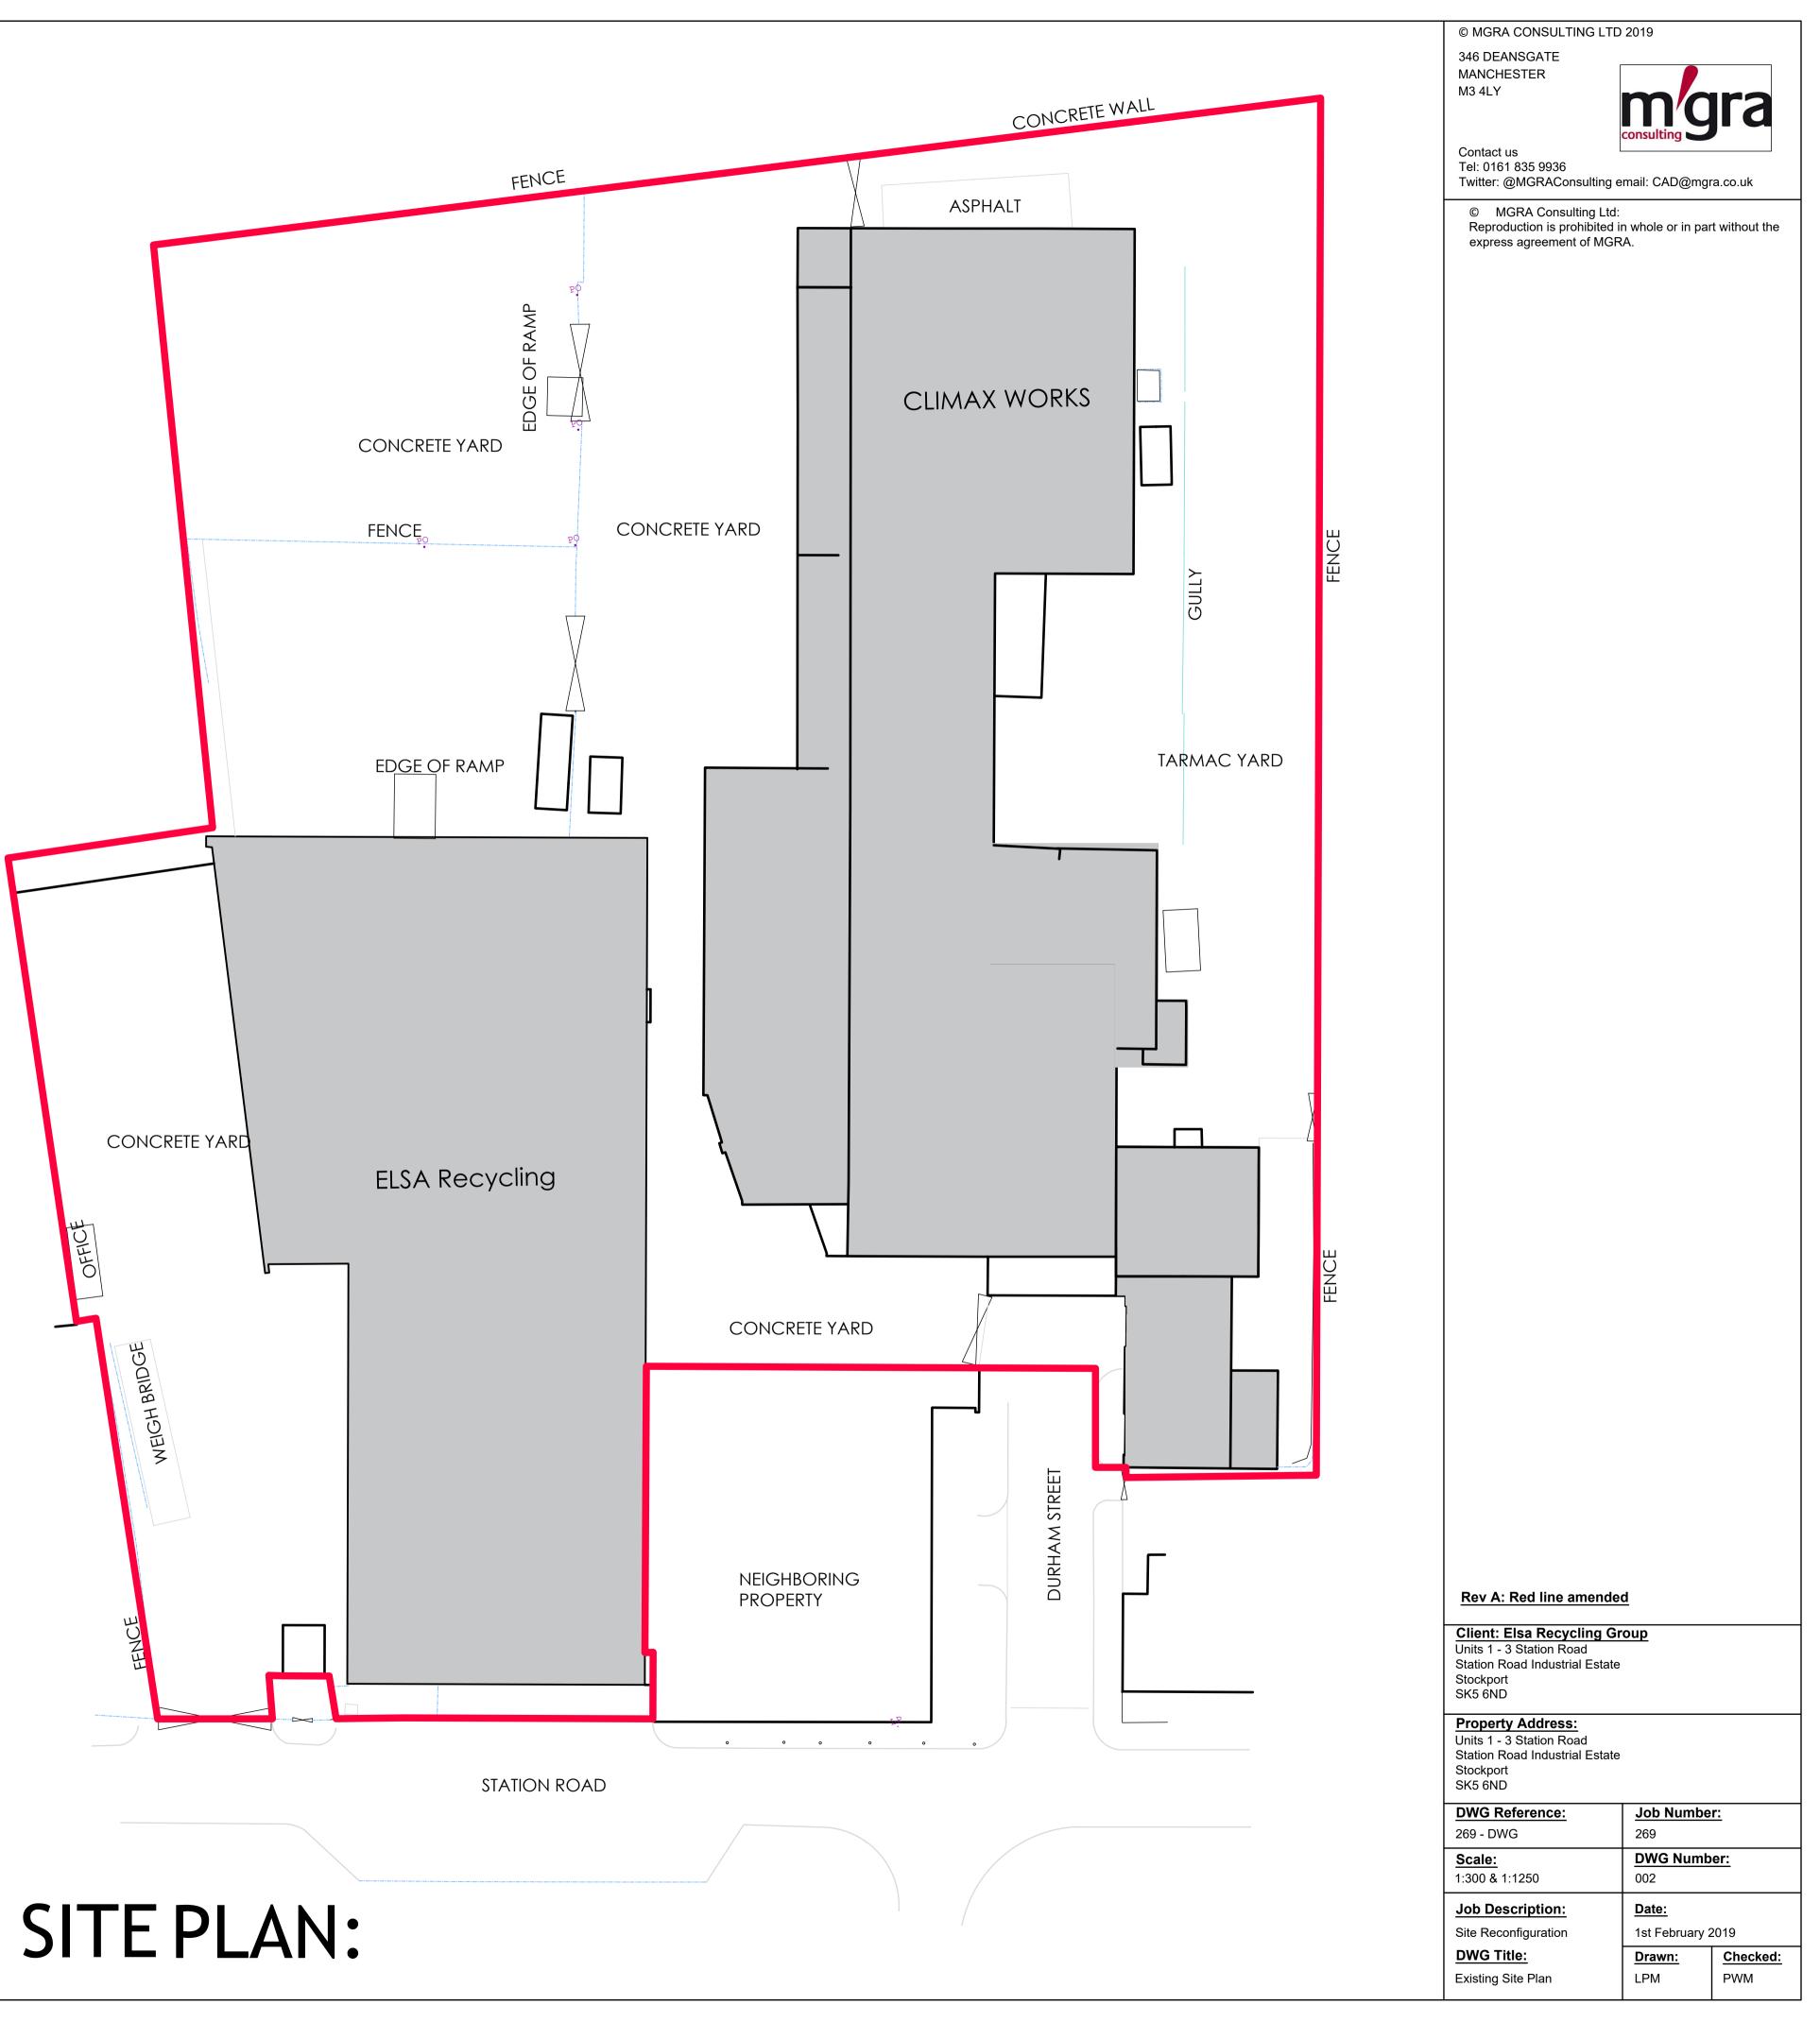


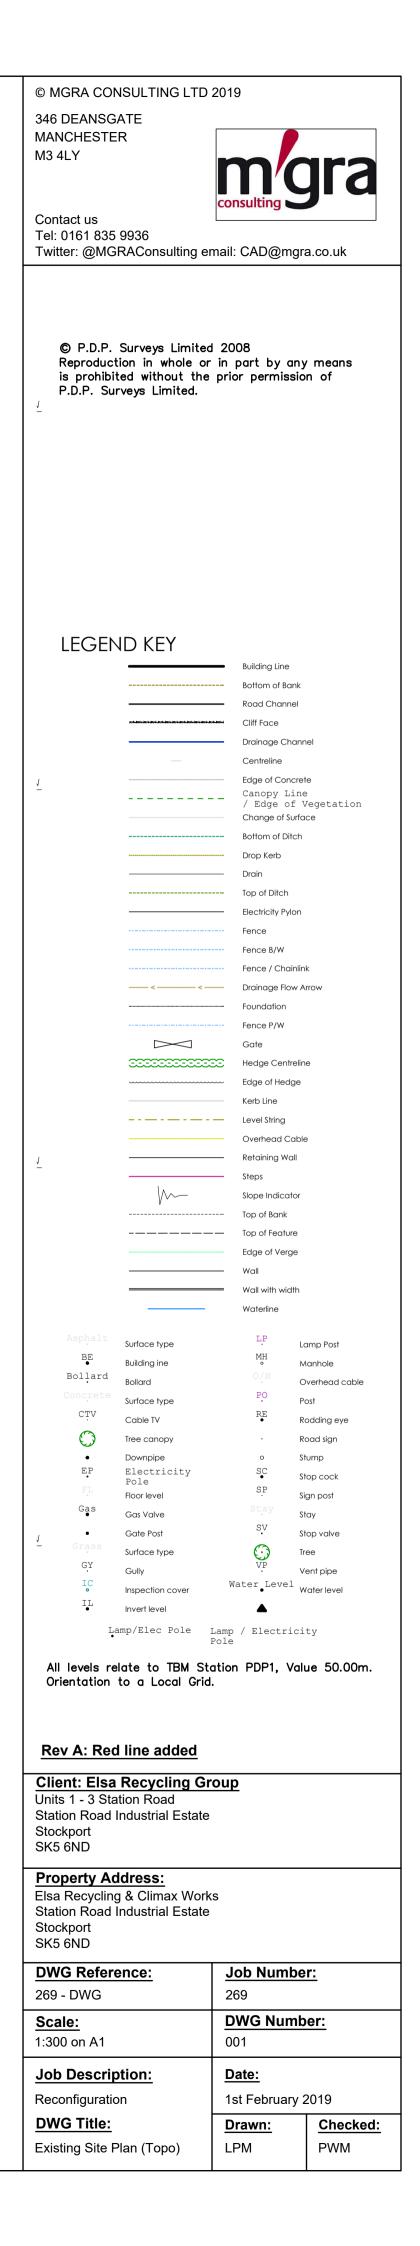





	Contact us Tel: 0161 835 9936 Twitter: @MGRAConsulting © MGRA Consulting Ltc	email: CAD@mgra.co.uk
MAX WORKS		
	<u>Rev A: Location Plan</u>	added_
	Client: Elsa Recycling G Units 1 - 3 Station Road Station Road Industrial Estat Stockport SK5 6ND	
	Property Address: Units 1 - 3 Station Road Station Road Industrial Estat Stockport SK5 6ND	
	DWG Reference: 269 - DWG Scale: 1:150 & 1:1250 on A1	Job Number:       269       DWG Number:       005
	Job Description:         Site Reconfiguration         DWG Title:	Date:       May 2020       Drawn:     Checked:
	ER EXISTING FLOOR PLANS	LPM PWM

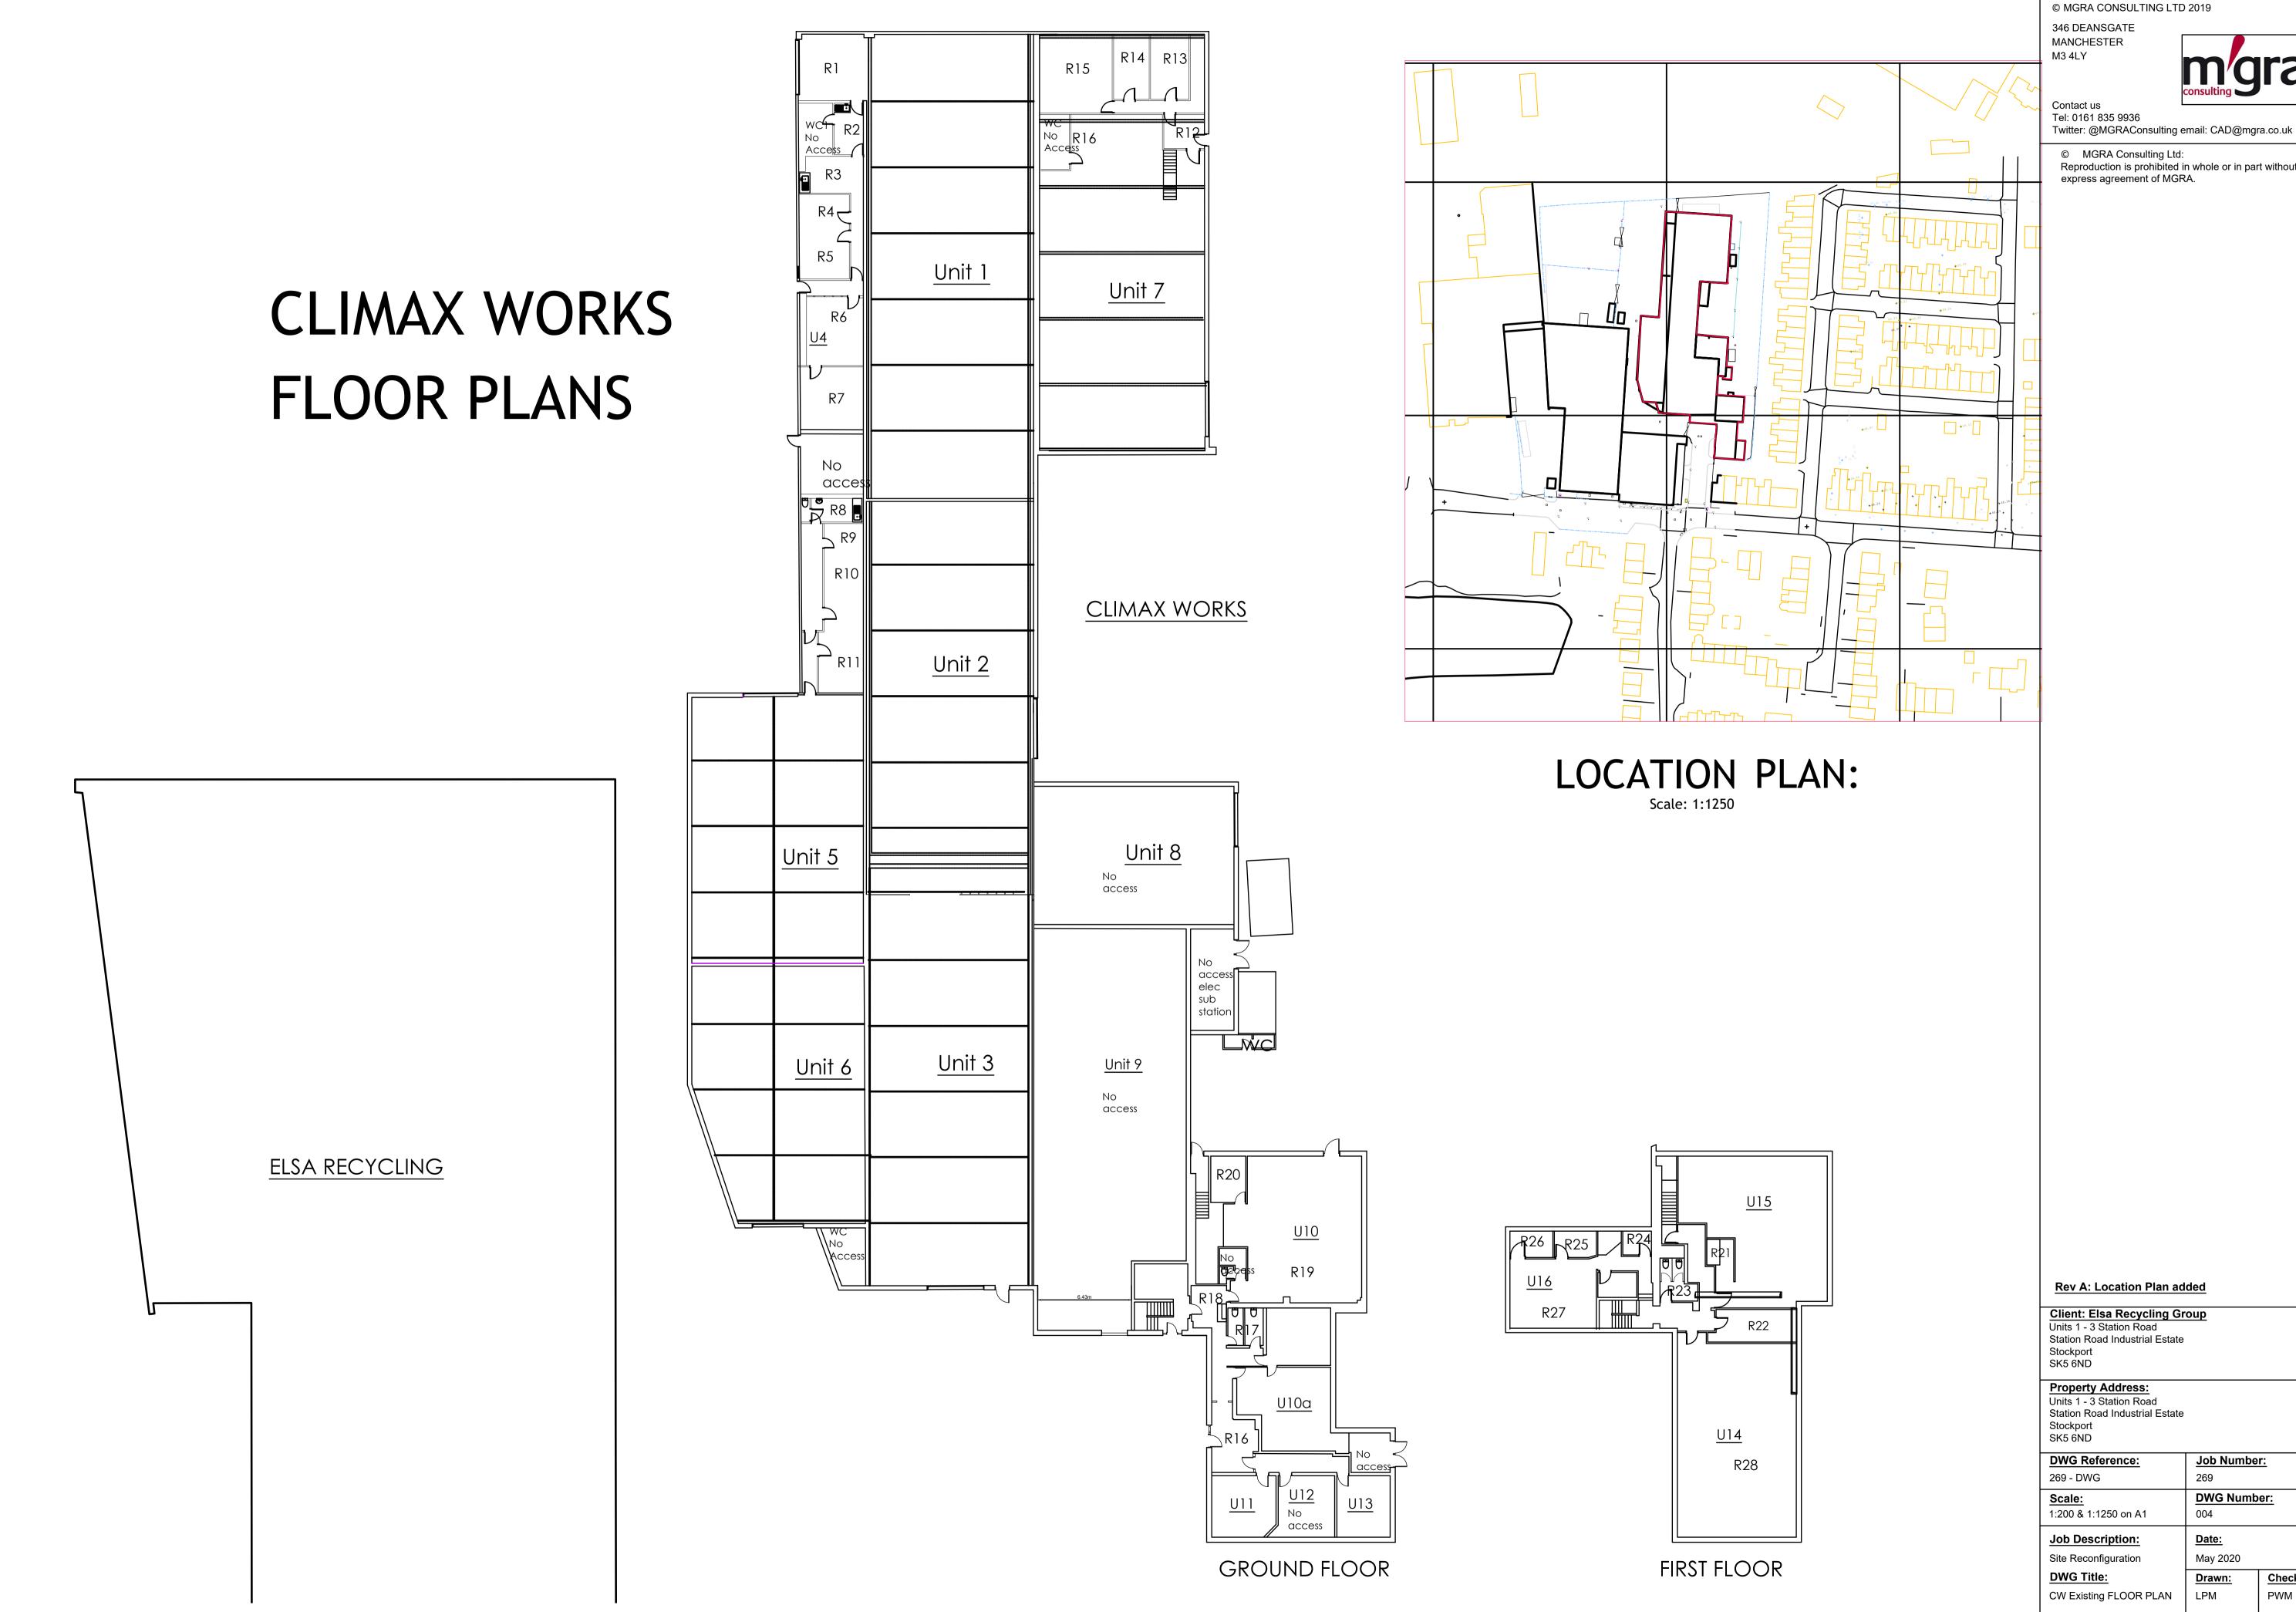



Job Number:

DWG Number:

Checked:

PWM

269

004

Date:

May 2020


Drawn:


LPM

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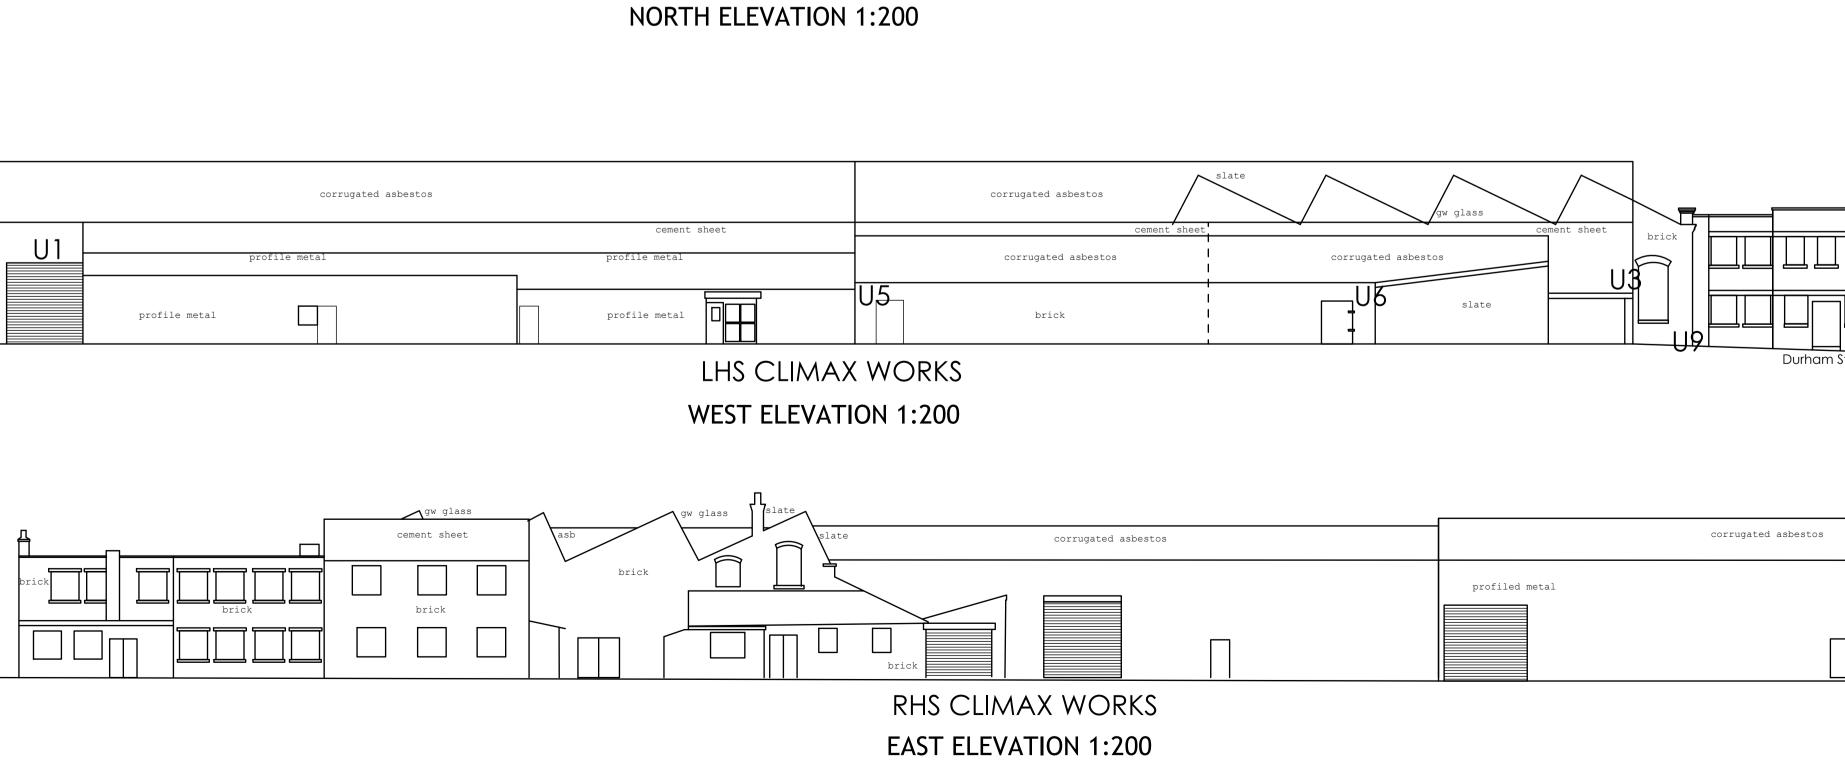






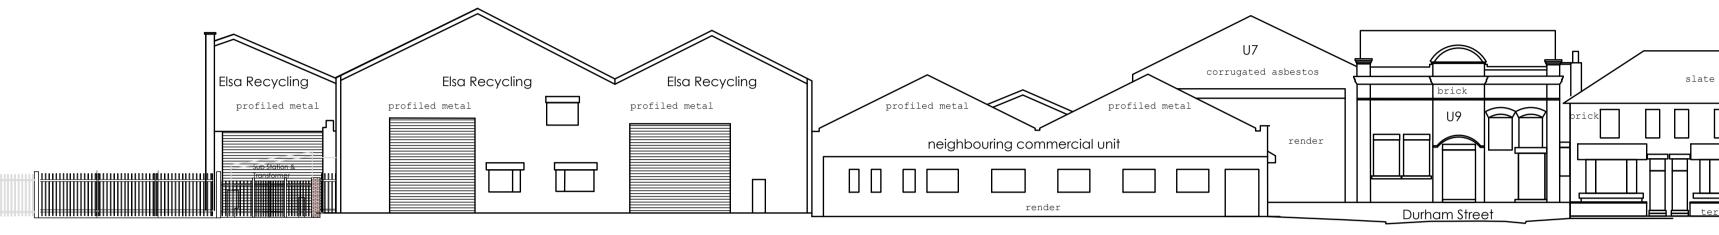

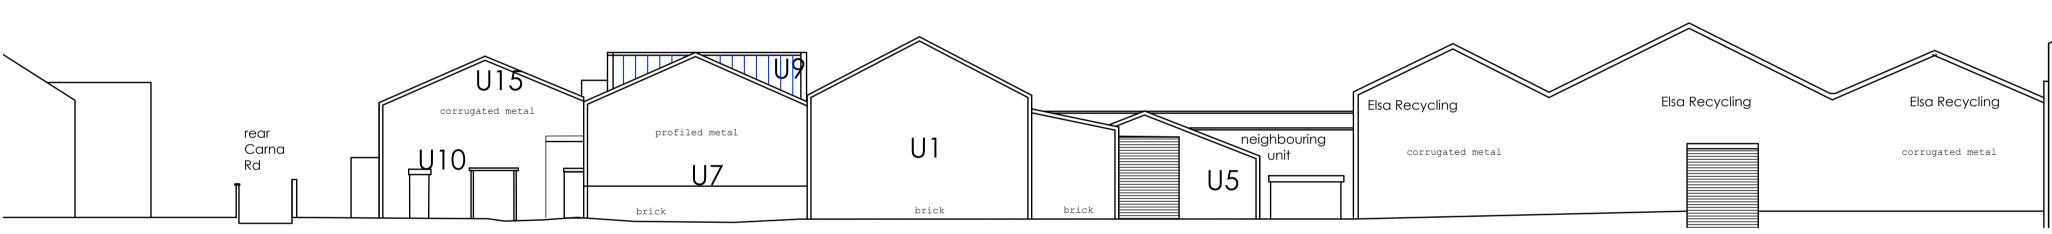
	corrugated asbestos	
U1	profile metal	pro
	profile metal	pro



## REAR ELEVATION ELSA AND CLIMAX WORKS

## FRONT ELEVATIONS ELSA AND CLIMAX WORKS SOUTH ELEVATION 1:200

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	Twitter: @MGRAConsulting         ©       MGRA Consulting Lt         Reproduction is prohibited         overross agreement of MC	d: d in whole or in part without the
	express agreement of MG	GRA.
-[]		
eigboring dustrial		
nit (BH Precision)		
	Rev A: Location Plan	
	Client: Elsa Recycling Units 1 - 3 Station Road Station Road Industrial Esta Stockport SK5 6ND	
	Property Address: Units 1 - 3 Station Road Station Road Industrial Esta Stockport SK5 6ND	ate
	DWG Reference: 269 - DWG	269 DWG Number:
	Scale: MULTIPLE Job Description:	DWG Number: 006 Date:
	Site Reconfiguration DWG Title:	May 2020 Drawn: Checked:
	Existing Elevations	LPM PWM

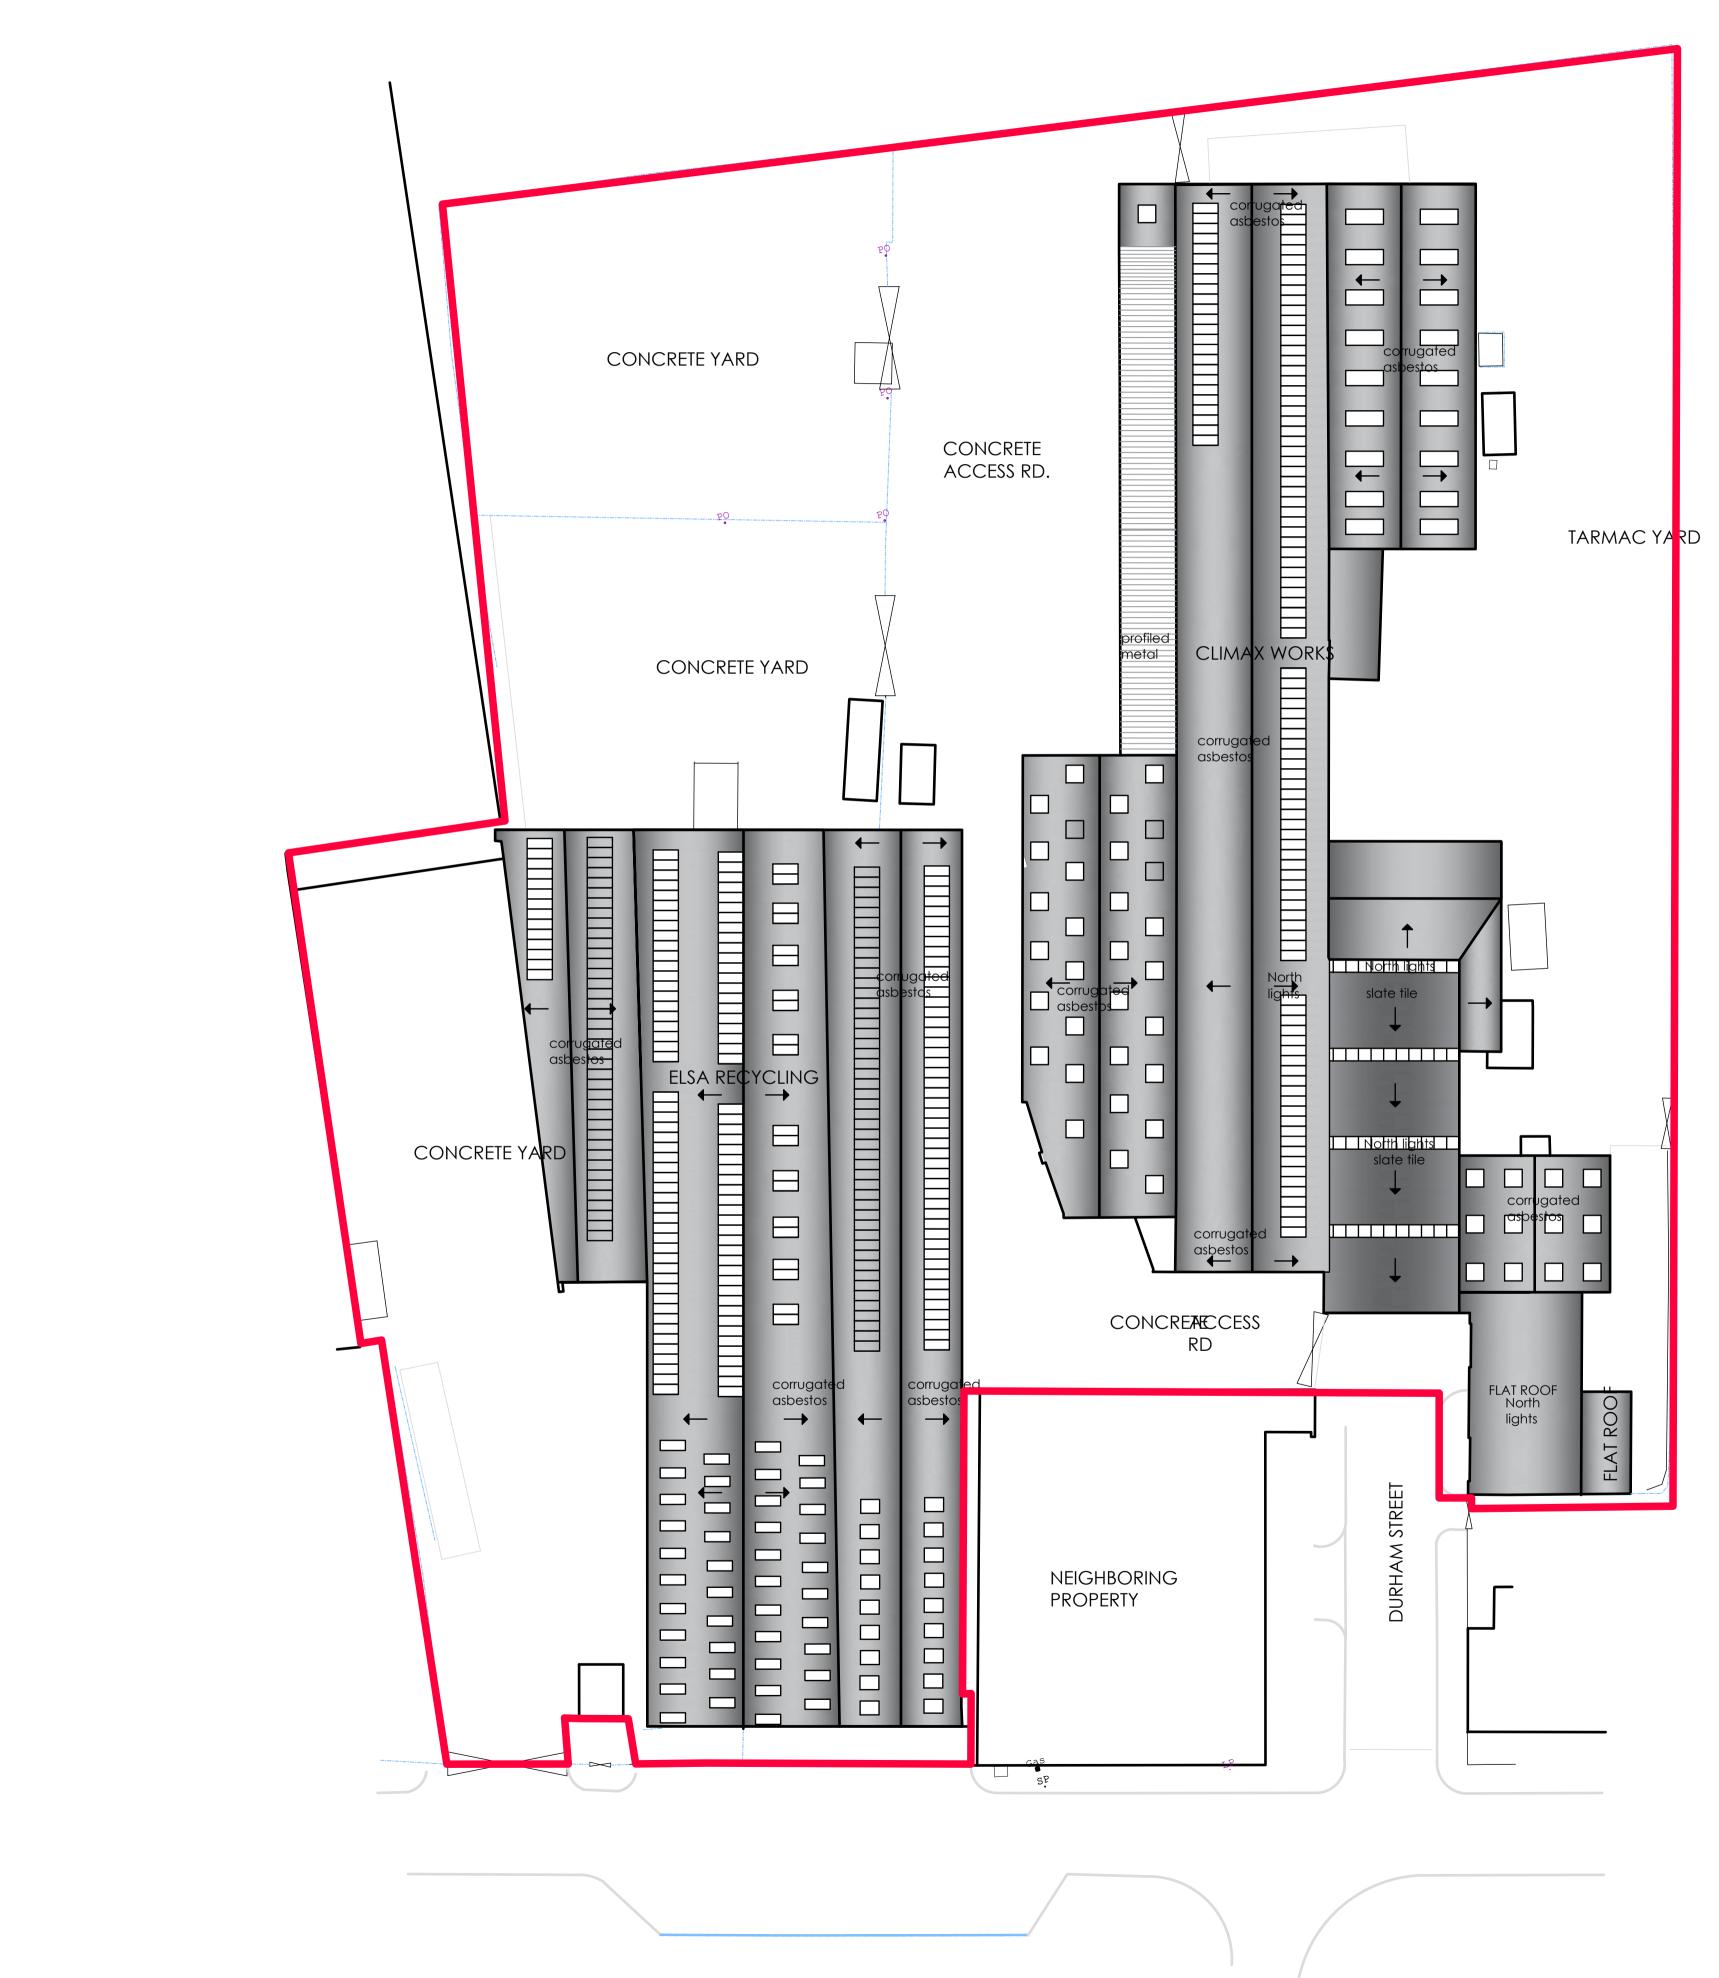

# **ROOF PLAN**

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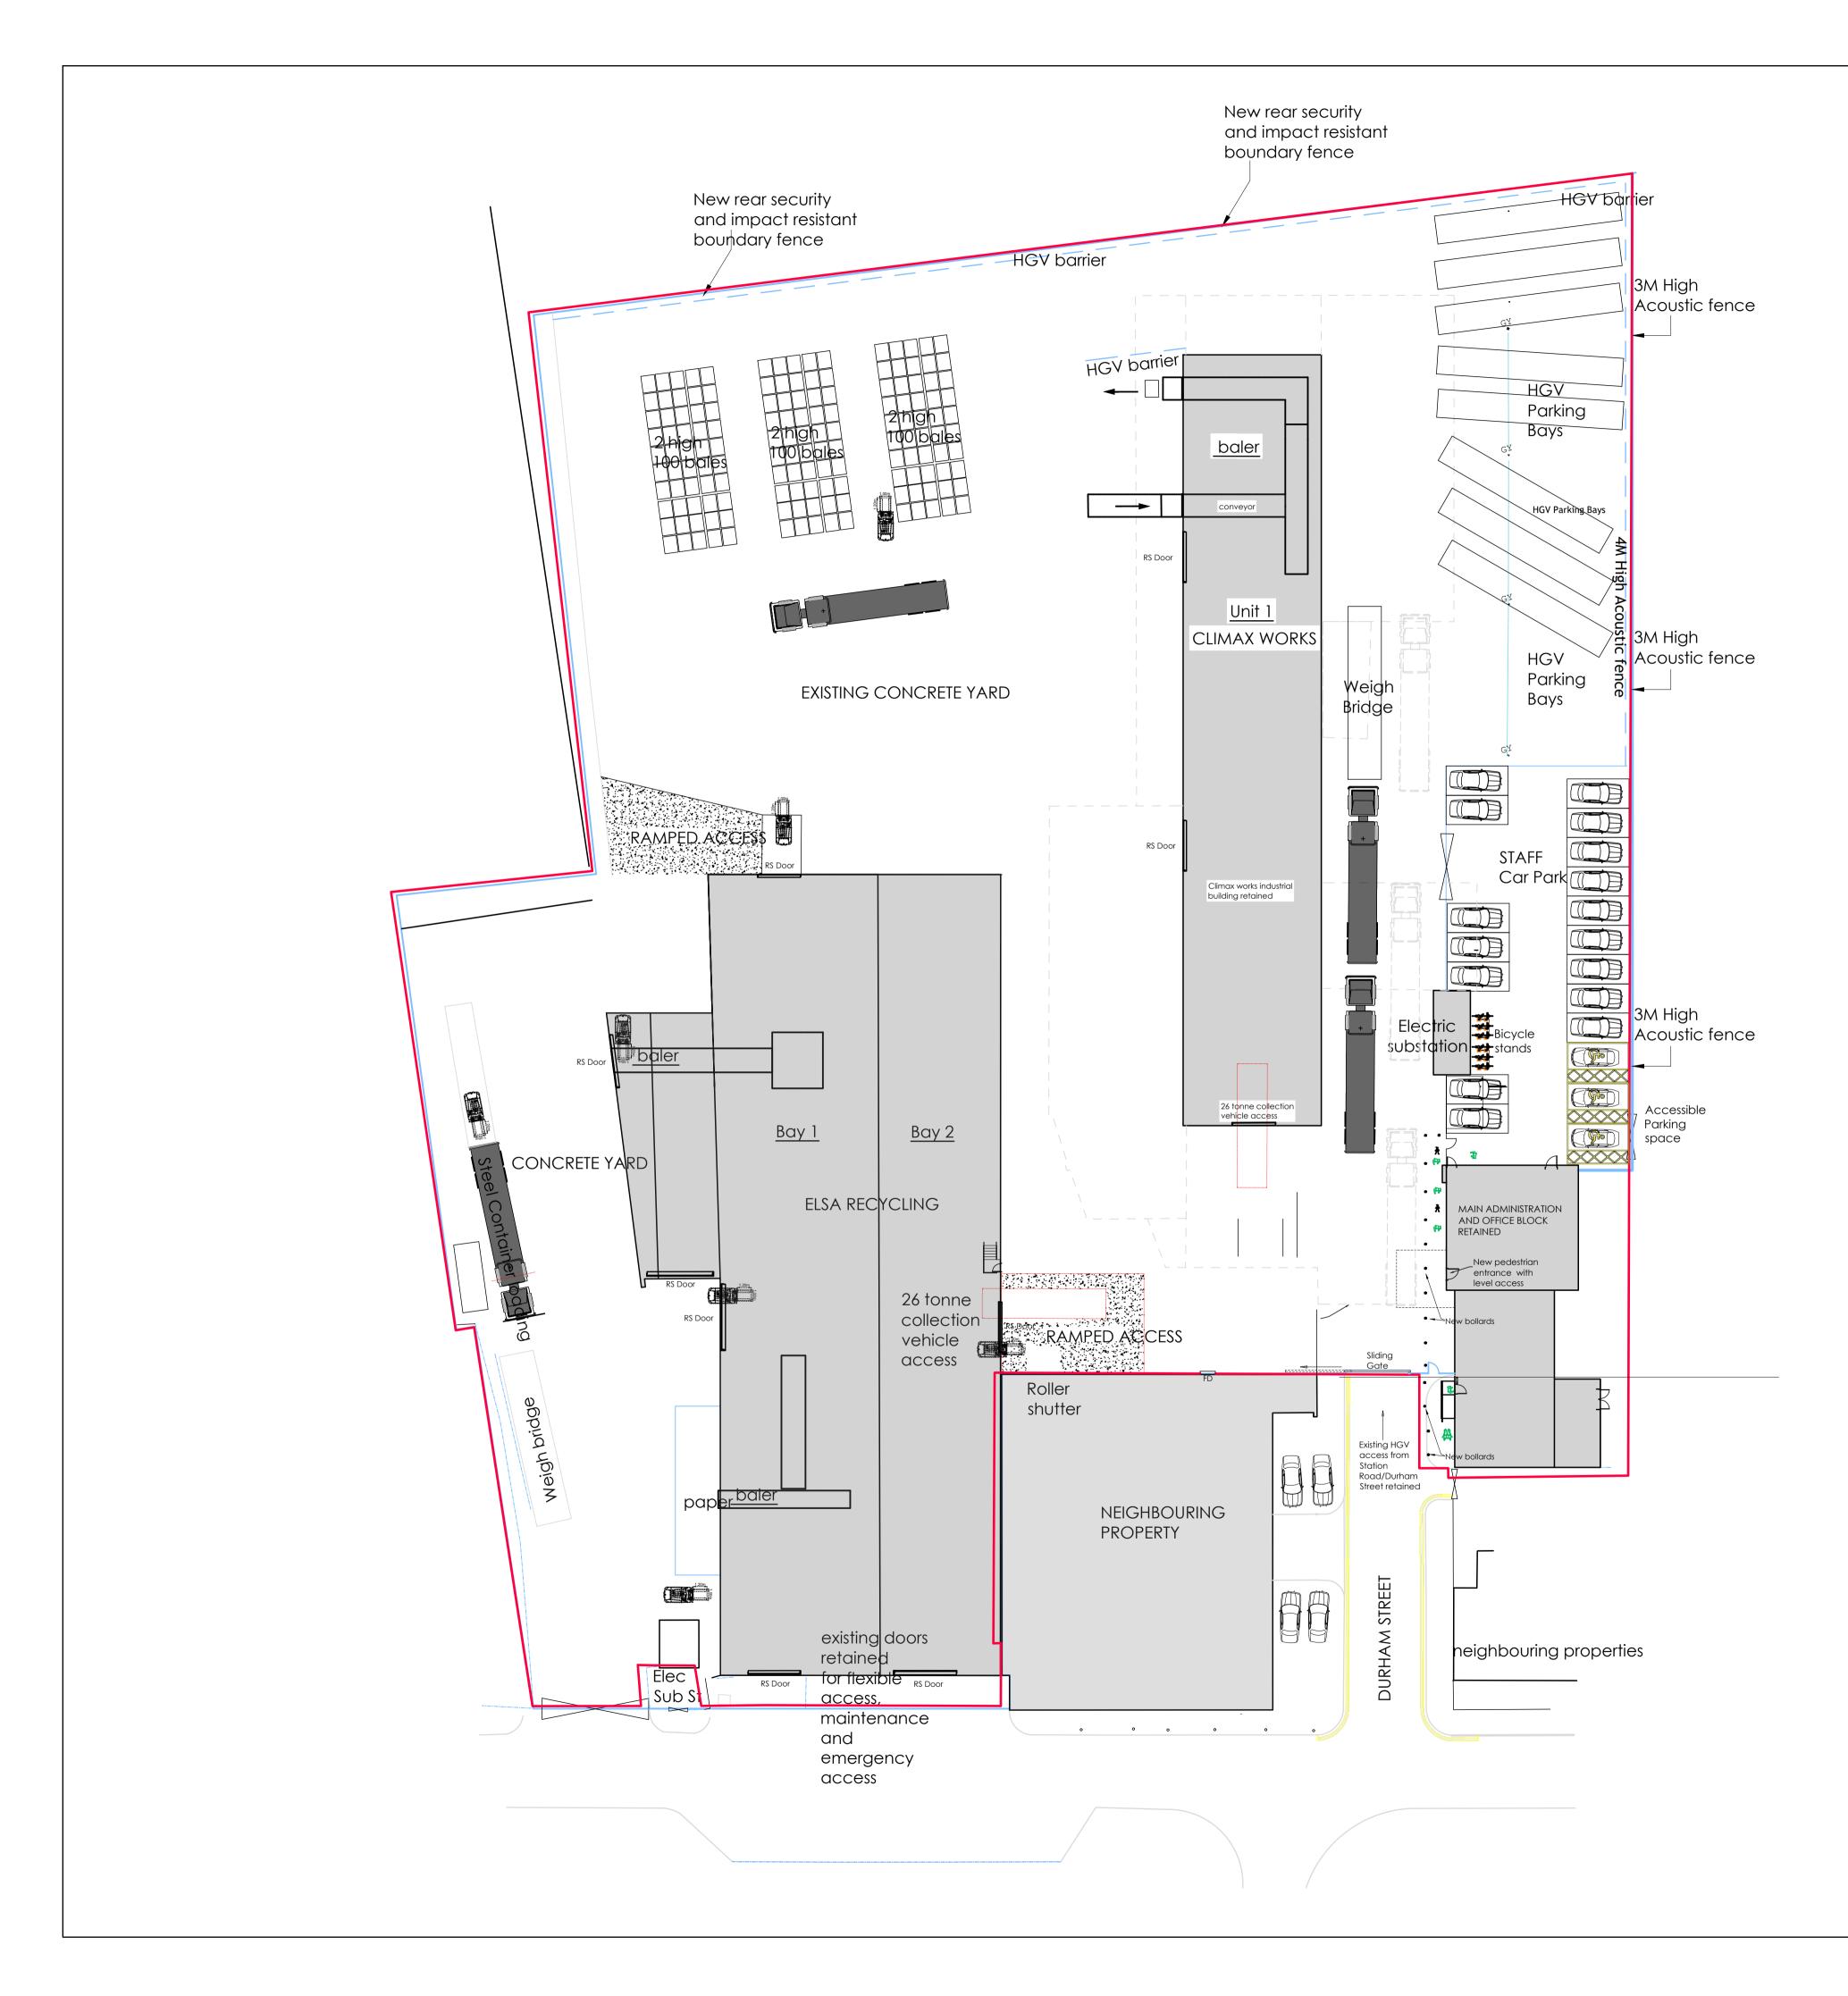


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#### Rev A: Red Line amended

Client: Elsa Recycling Gr Units 1 - 3 Station Road Station Road Industrial Estate Stockport SK5 6ND	<u>oup</u>	
Property Address: Units 1 - 3 Station Road Station Road Industrial Estate Stockport SK5 6ND		
DWG Reference:	Job Numbe	r:
269 - DWG	269	_
Scale:	DWG Numb	er:
1:300 on A1	003	
Job Description:	Date:	
Site Reconfiguration	May 2020	
DWG Title:	Drawn:	Checked:
ROOF PLAN	LPM	PWM



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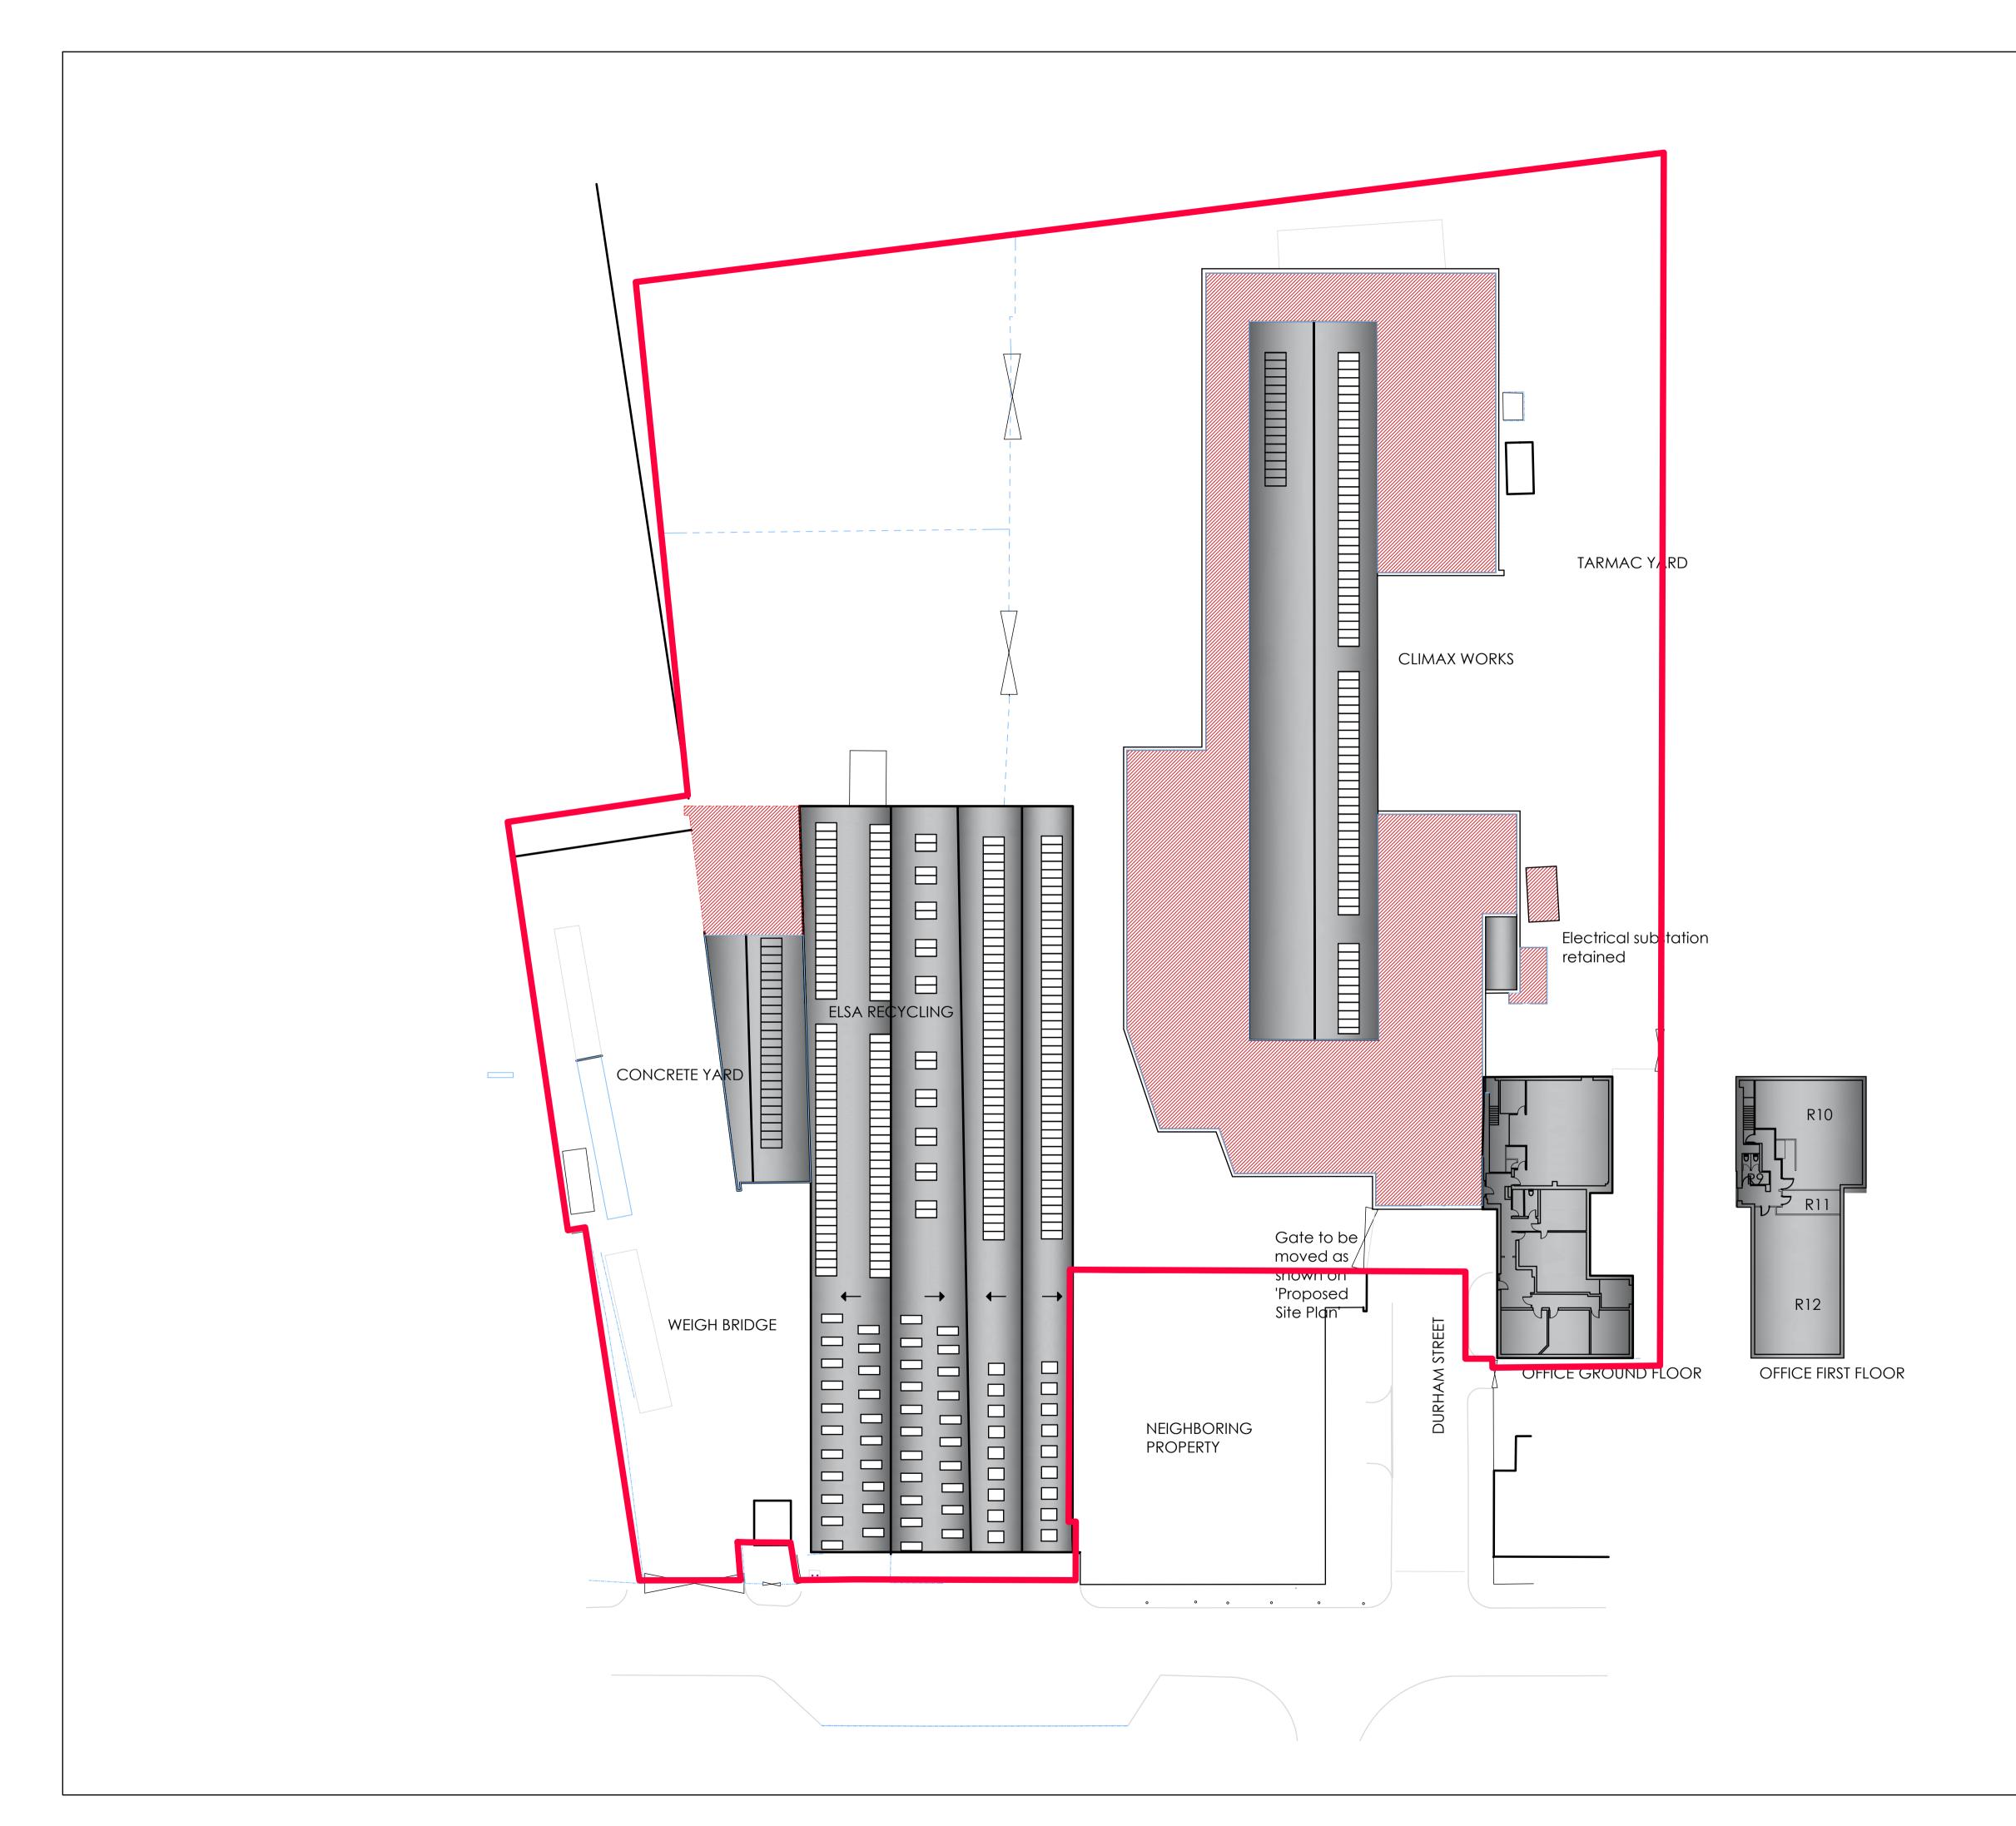


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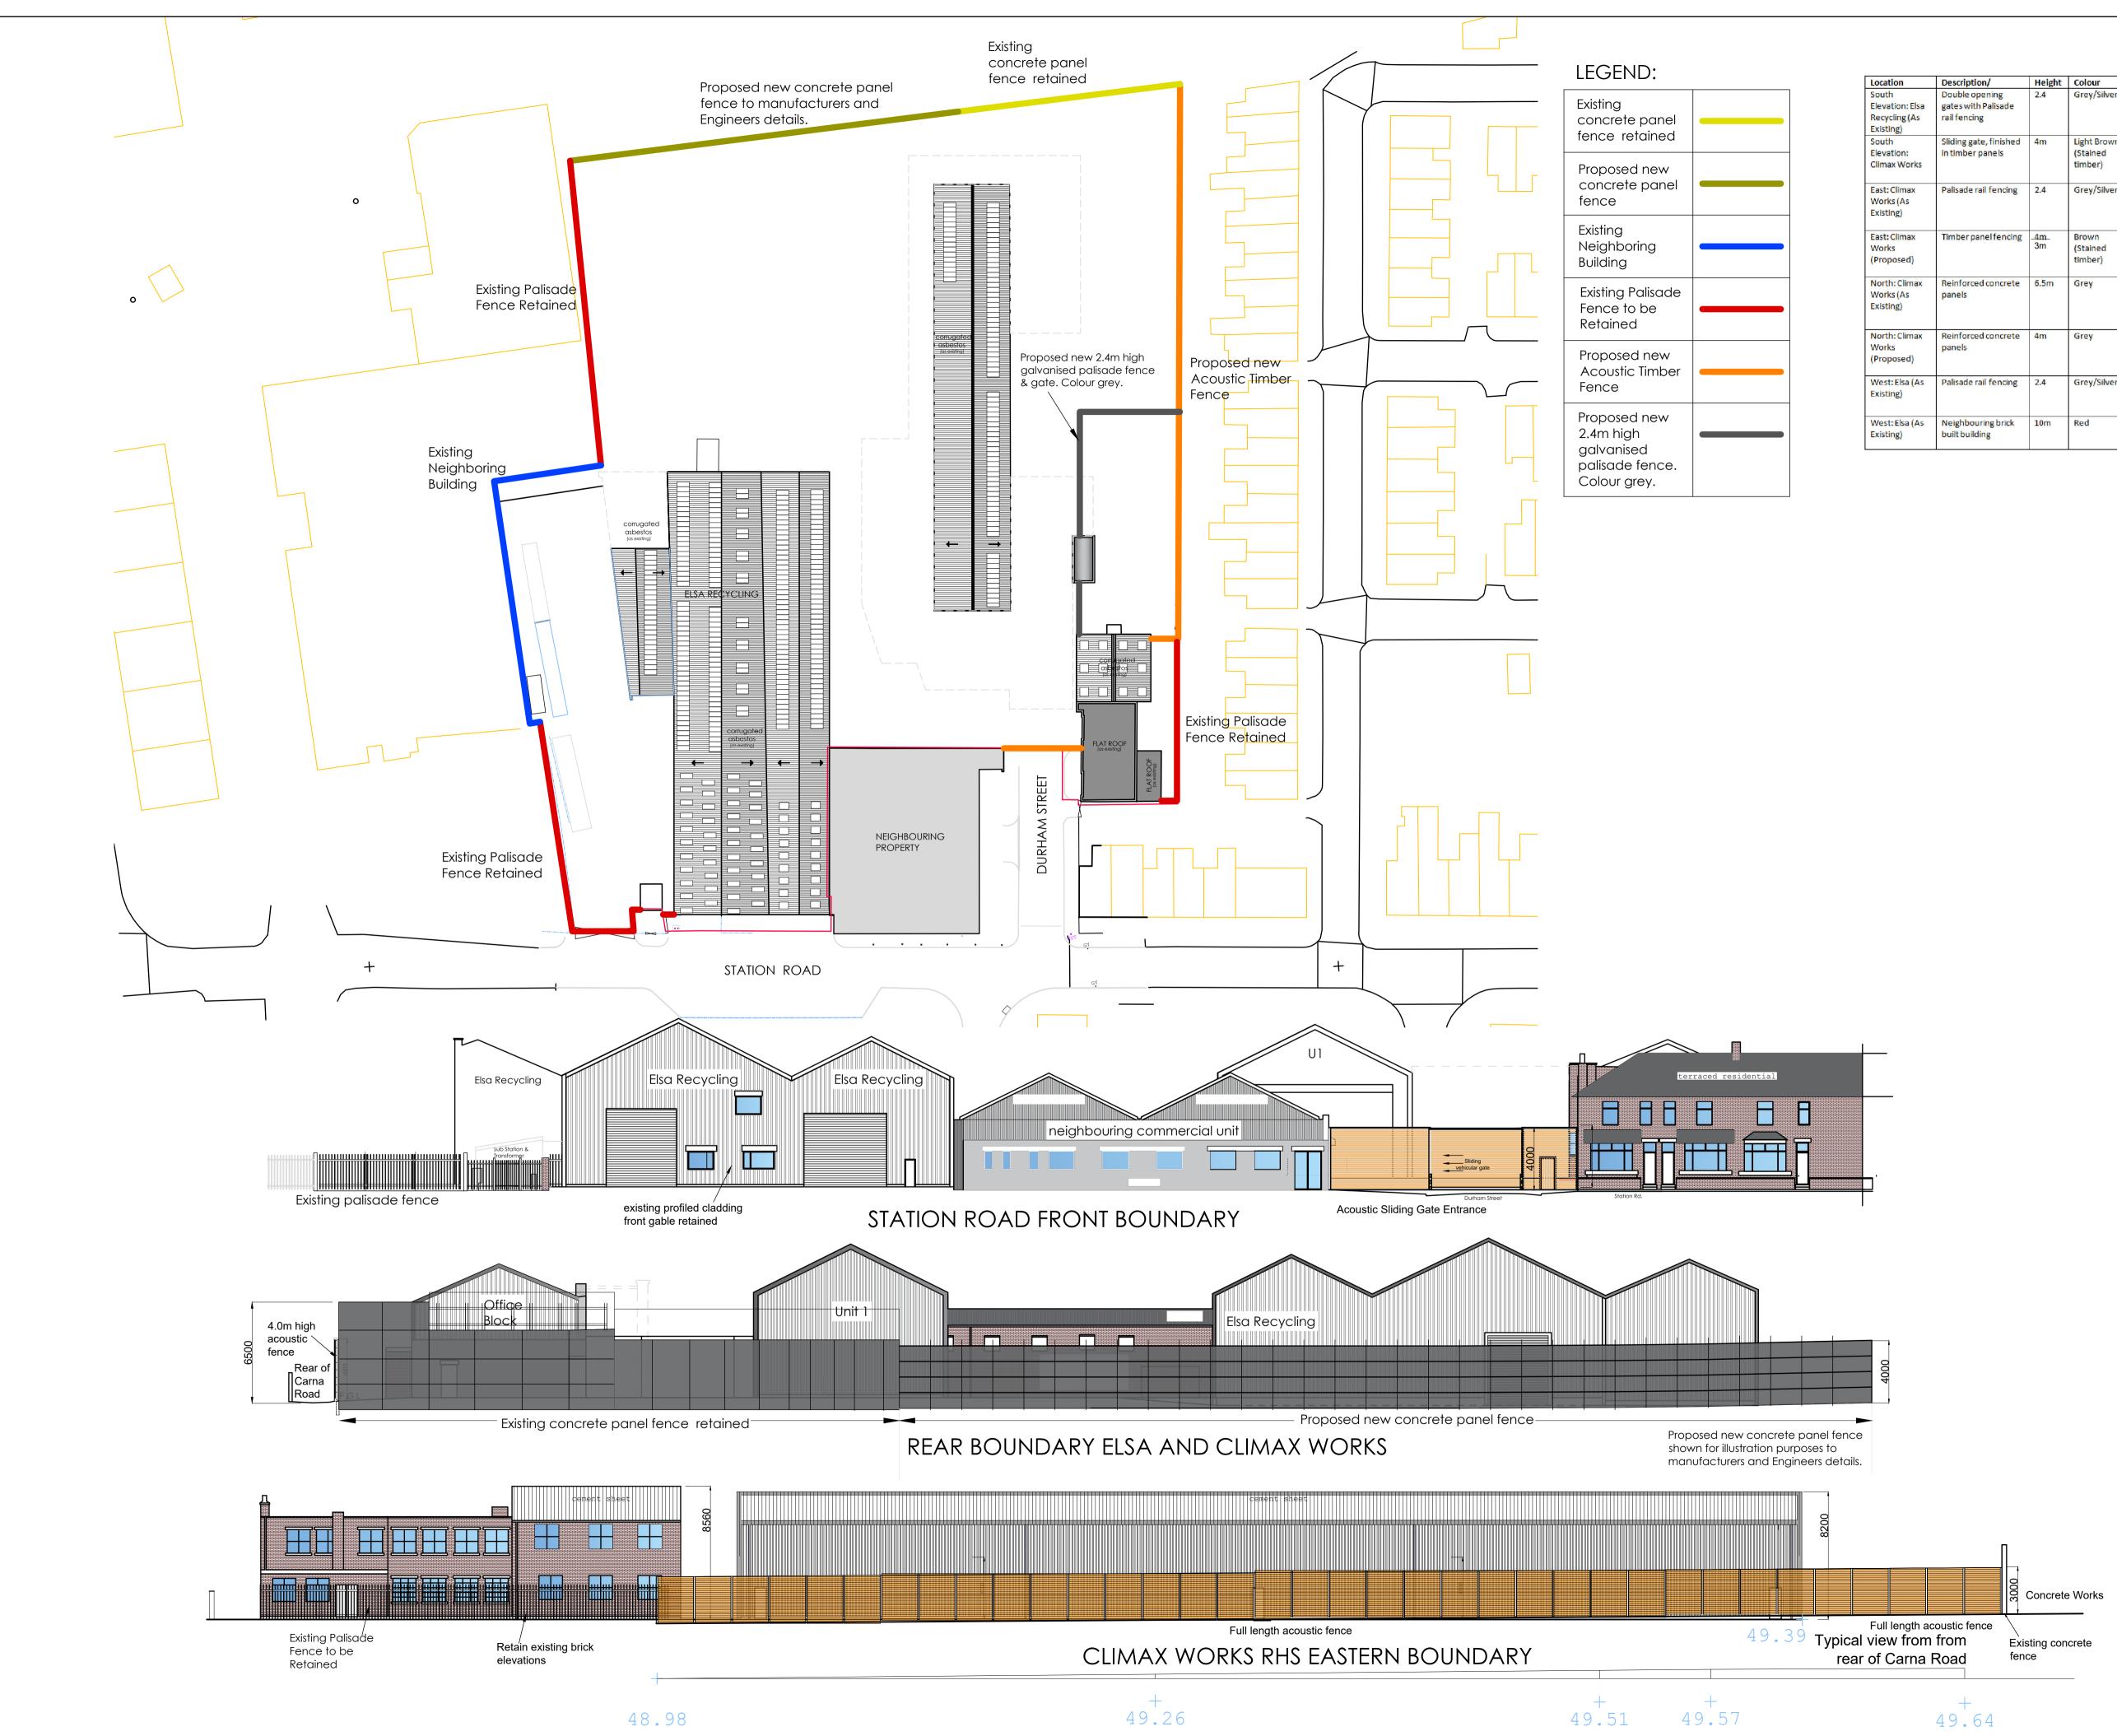
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Rev I: East fence reduced to 3m **Rev H: Yellow lines amended** Rev G: Vehicles shown and yellow lines added Rev F: Nov 2020 stair block removed Rev E: October 2020 access amendments Rev D: August 2020 barrier amendments Rev C: July 2020 Baler orientation Rev B: June 2020 HGV orientation changes Client: Elsa Recycling Group Units 1 - 3 Station Road Station Road Industrial Estate Stockport SK5 6ND Property Address: Units 1 - 3 Station Road Station Road Industrial Estate Stockport SK5 6ND Job Number: DWG Reference: 269 - DWG 269 DWG Number: Scale: 1:300 on A1 011 Date: Job Description: Site Reconfiguration May 2020 DWG Title: Drawn: Checked: LPM PWM PROPOSED SITE

PLAN



© MGRA CONSULTING LTD 2019 346 DEANSGATE MANCHESTER M3 4LY mgra Contact us Tel: 0161 835 9936 Twitter: @MGRAConsulting email: CAD@mgra.co.uk © MGRA Consulting Ltd: Reproduction is prohibited in whole or in part without the express agreement of MGRA. Buildings to be removed and made good **Buildings to be retained** repaired and refurbished Rev B: Red line altered Rev A: Stair block removed for vehicle access Client: Elsa Recycling Group Units 1 - 3 Station Road Station Road Industrial Estate Stockport SK5 6ND Property Address: Units 1 - 3 Station Road Station Road Industrial Estate Stockport SK5 6ND **DWG Reference:** Job Number: 269 - DWG 269 Scale: DWG Number: 1:300 on A1 010 Date: Job Description: May 2020 Site Reconfiguration DWG Title: Drawn: Checked: PROPOSED SITE DEMOLITION PLAN LPM PWM



	Description/	Height	Colour
ilsa \s	Double opening gates with Palisade rail fencing	2.4	Grey/Silver
ks	Sliding gate, finished in timber panels	4m	Light Brown (Stained timber)
¢	Palisade rail fencing	2.4	Grey/Silver
¢	Timber panel fencing	_4m_ 3m	Brown (Stained timber)
ах	Reinforced concrete panels	6.5m	Grey
ах	Reinforced concrete panels	4m	Grey
As	Palisade rail fencing	2.4	Grey/Silver
As	Neighbouring brick built building	10m	Red

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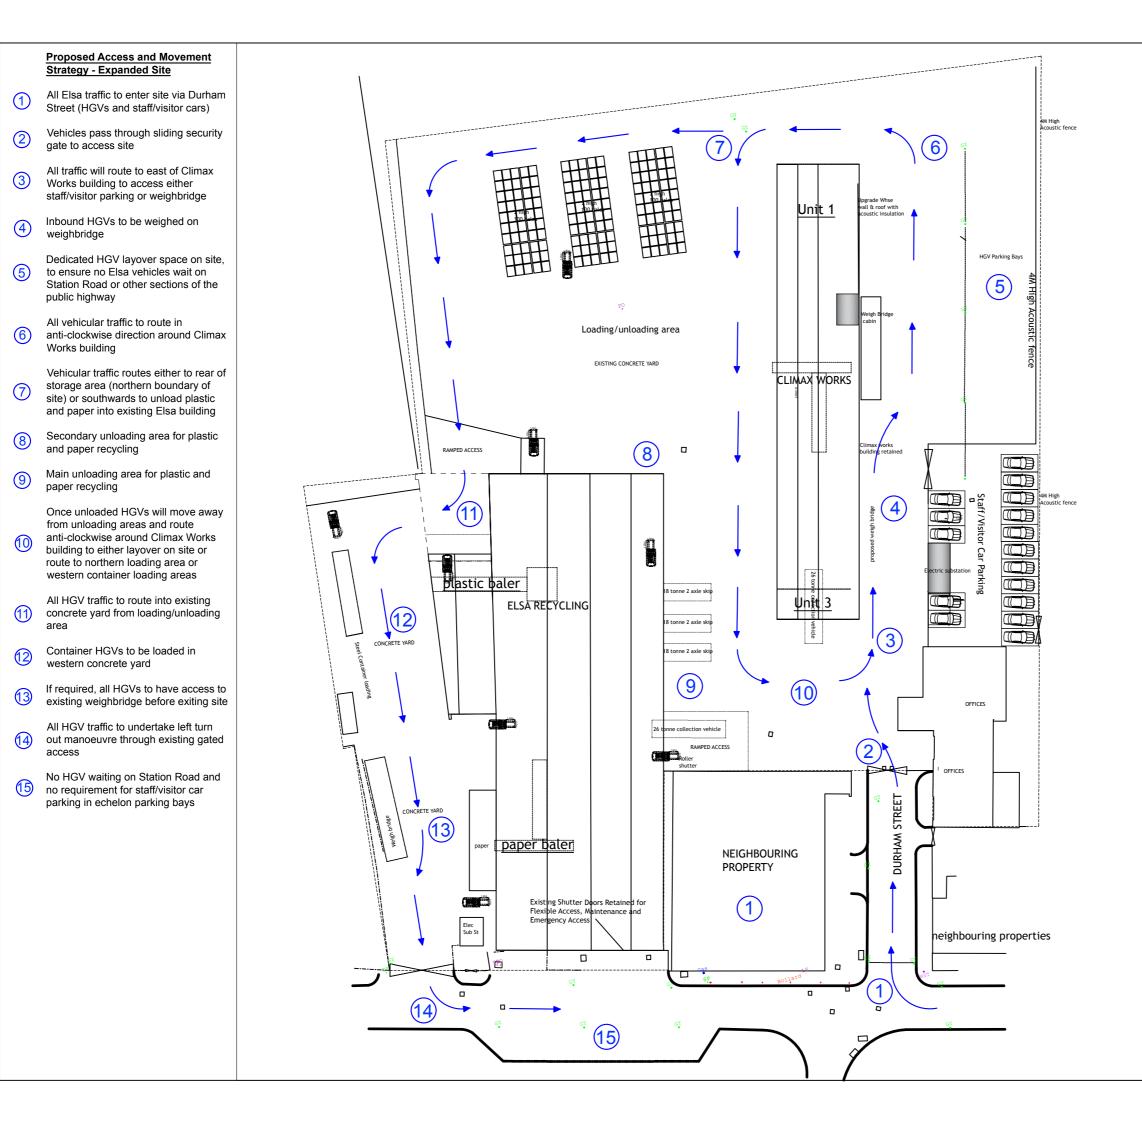
	Rev D:	Fence	reduced	to 3m
--	--------	-------	---------	-------


### Rev C: Fence stepped in line with topography drawing


Rev B: Amendments to rear fence


Rev A: March 2022 Amendments to rear fence


Client: Elsa Recycling Gr Units 1 - 3 Station Road Station Road Industrial Estate Stockport SK5 6ND	oup	
Property Address: Units 1 - 3 Station Road Station Road Industrial Estate Stockport SK5 6ND		
DWG Reference:	Job Numbe	<u>r:</u>
269 - DWG	269	
Scale:	DWG Numb	er:
1:200 & 1:500 on A1	008	
Job Description:	Date:	
Site Reconfiguration	1st February 2019	
DWG Title:	Drawn:	Checked:
PROPOSED BOUNDARY PLAN	LPM	PWM



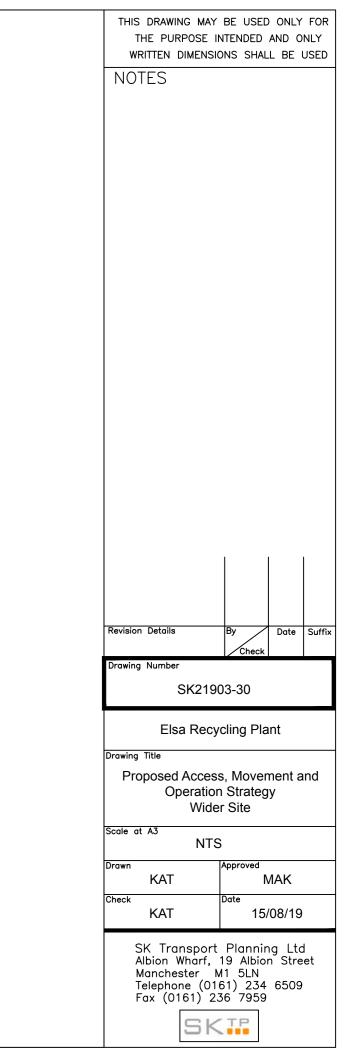


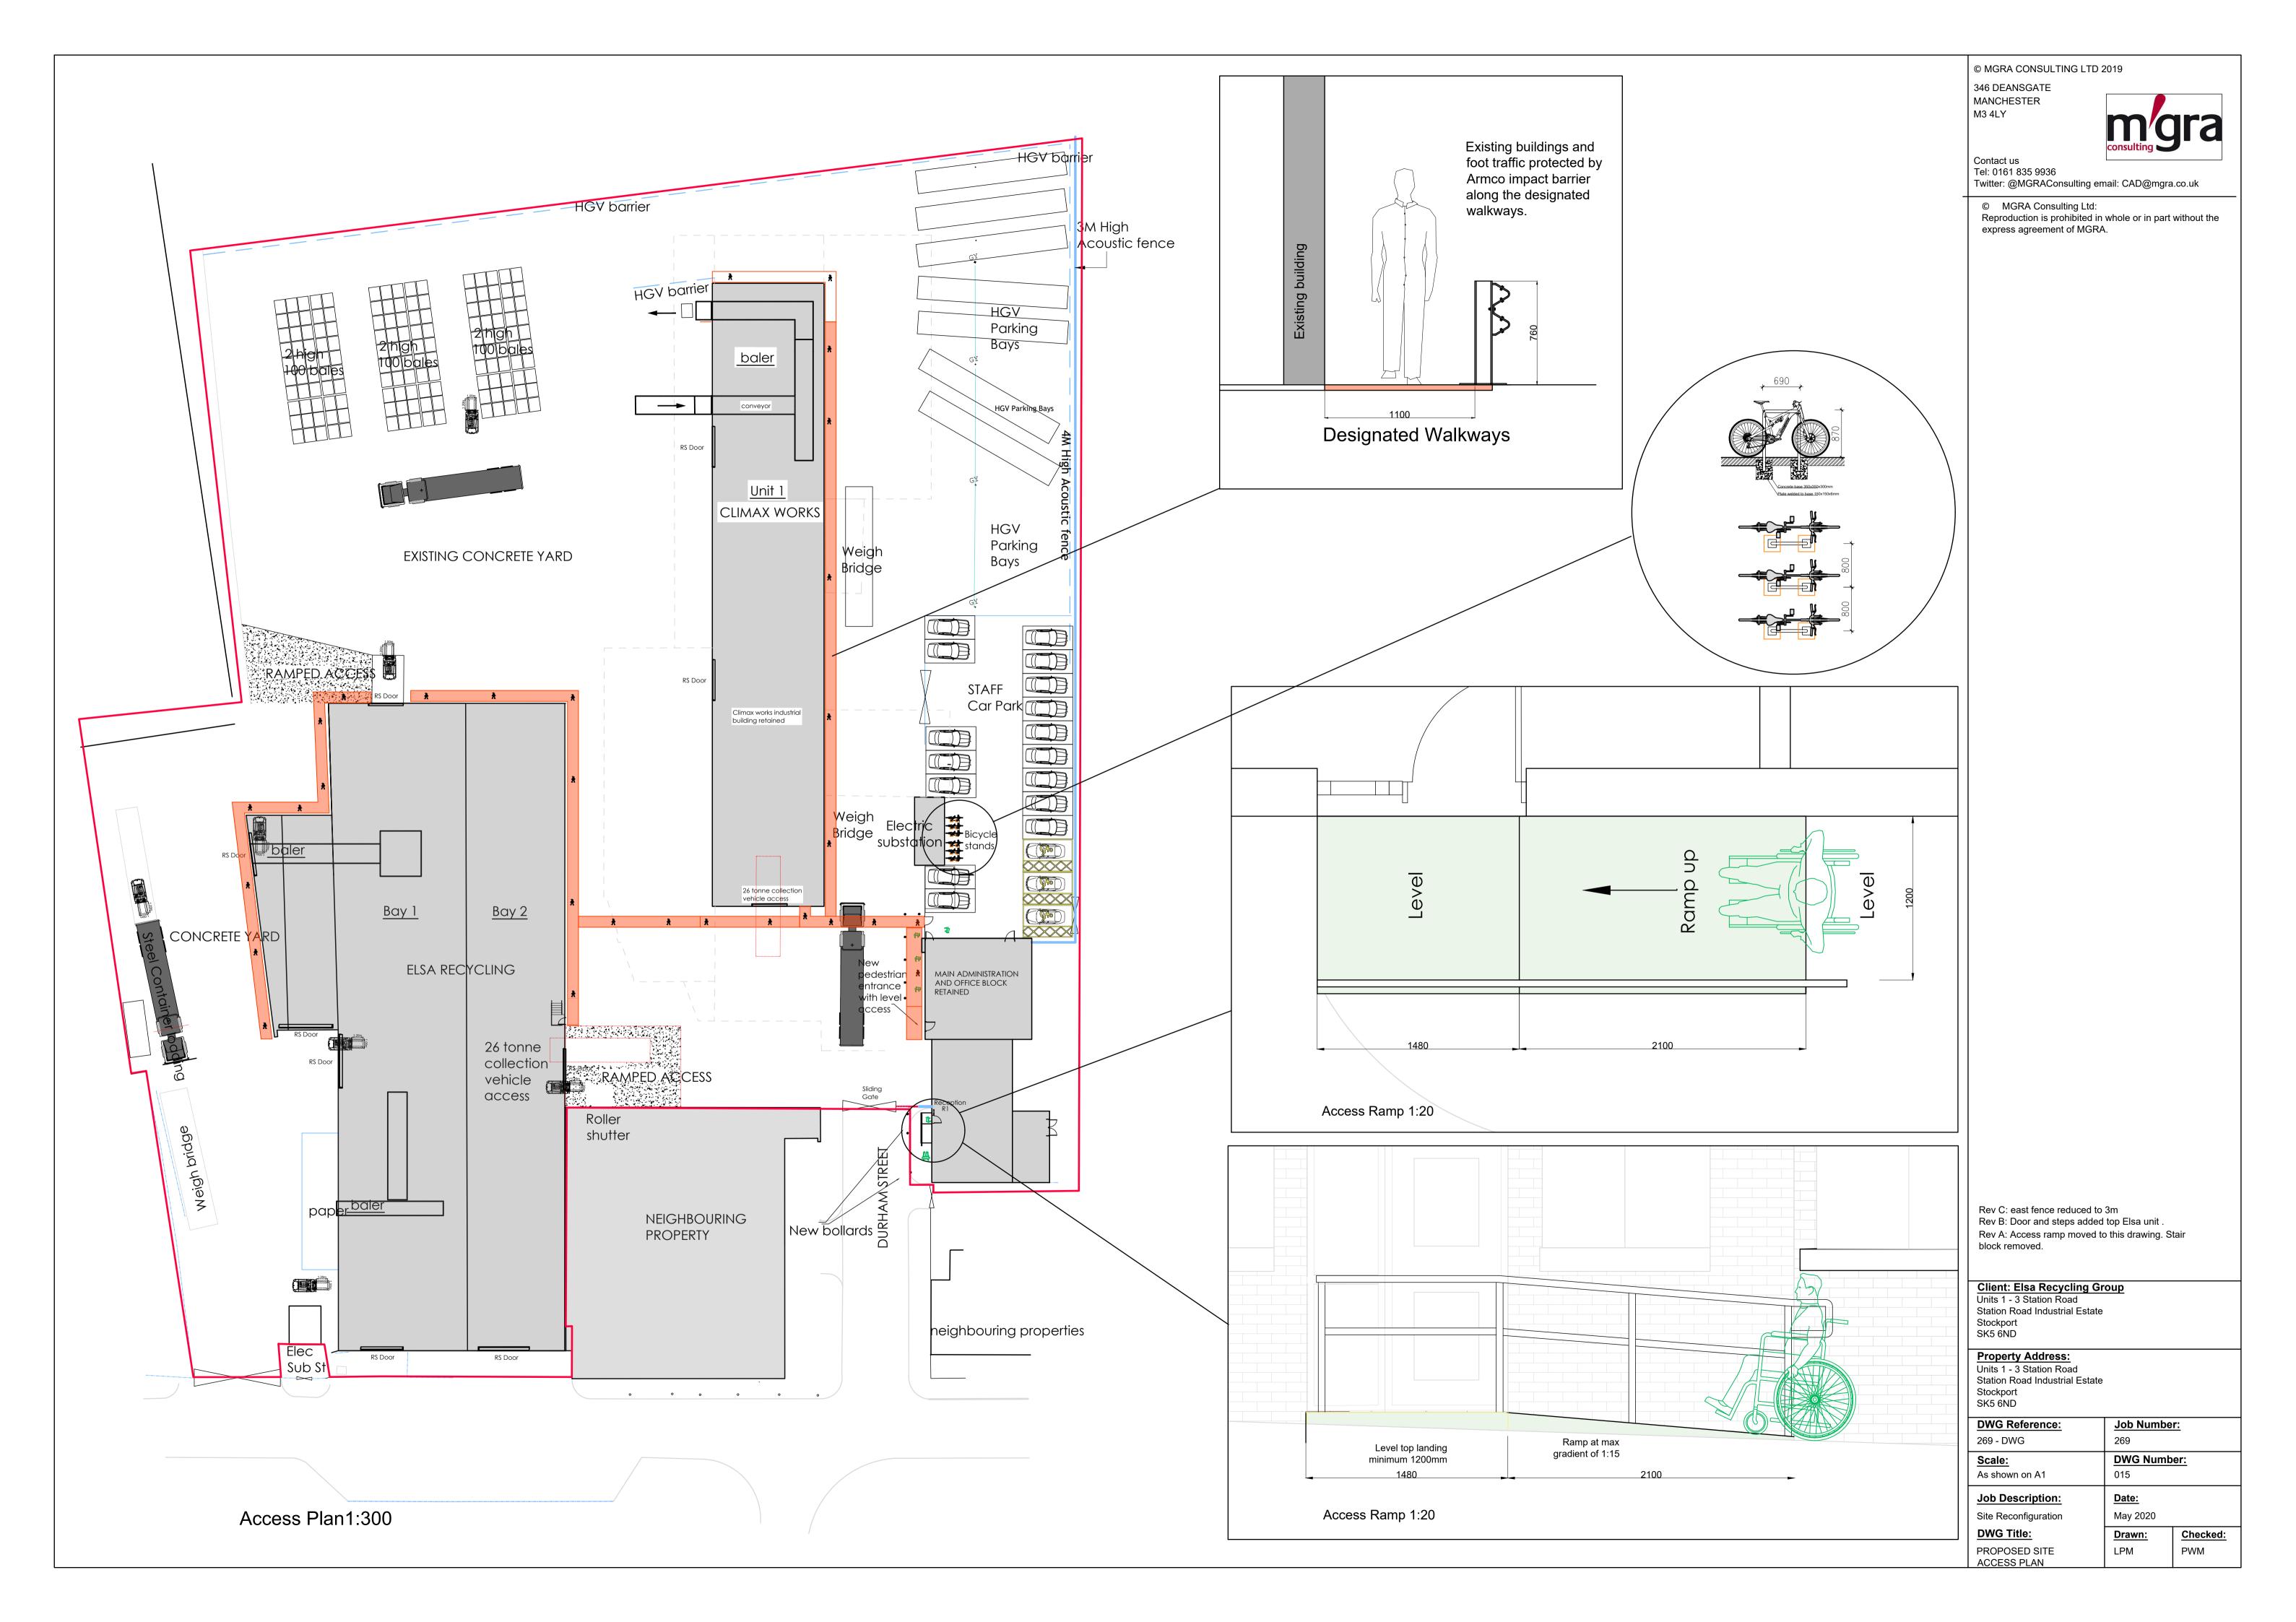

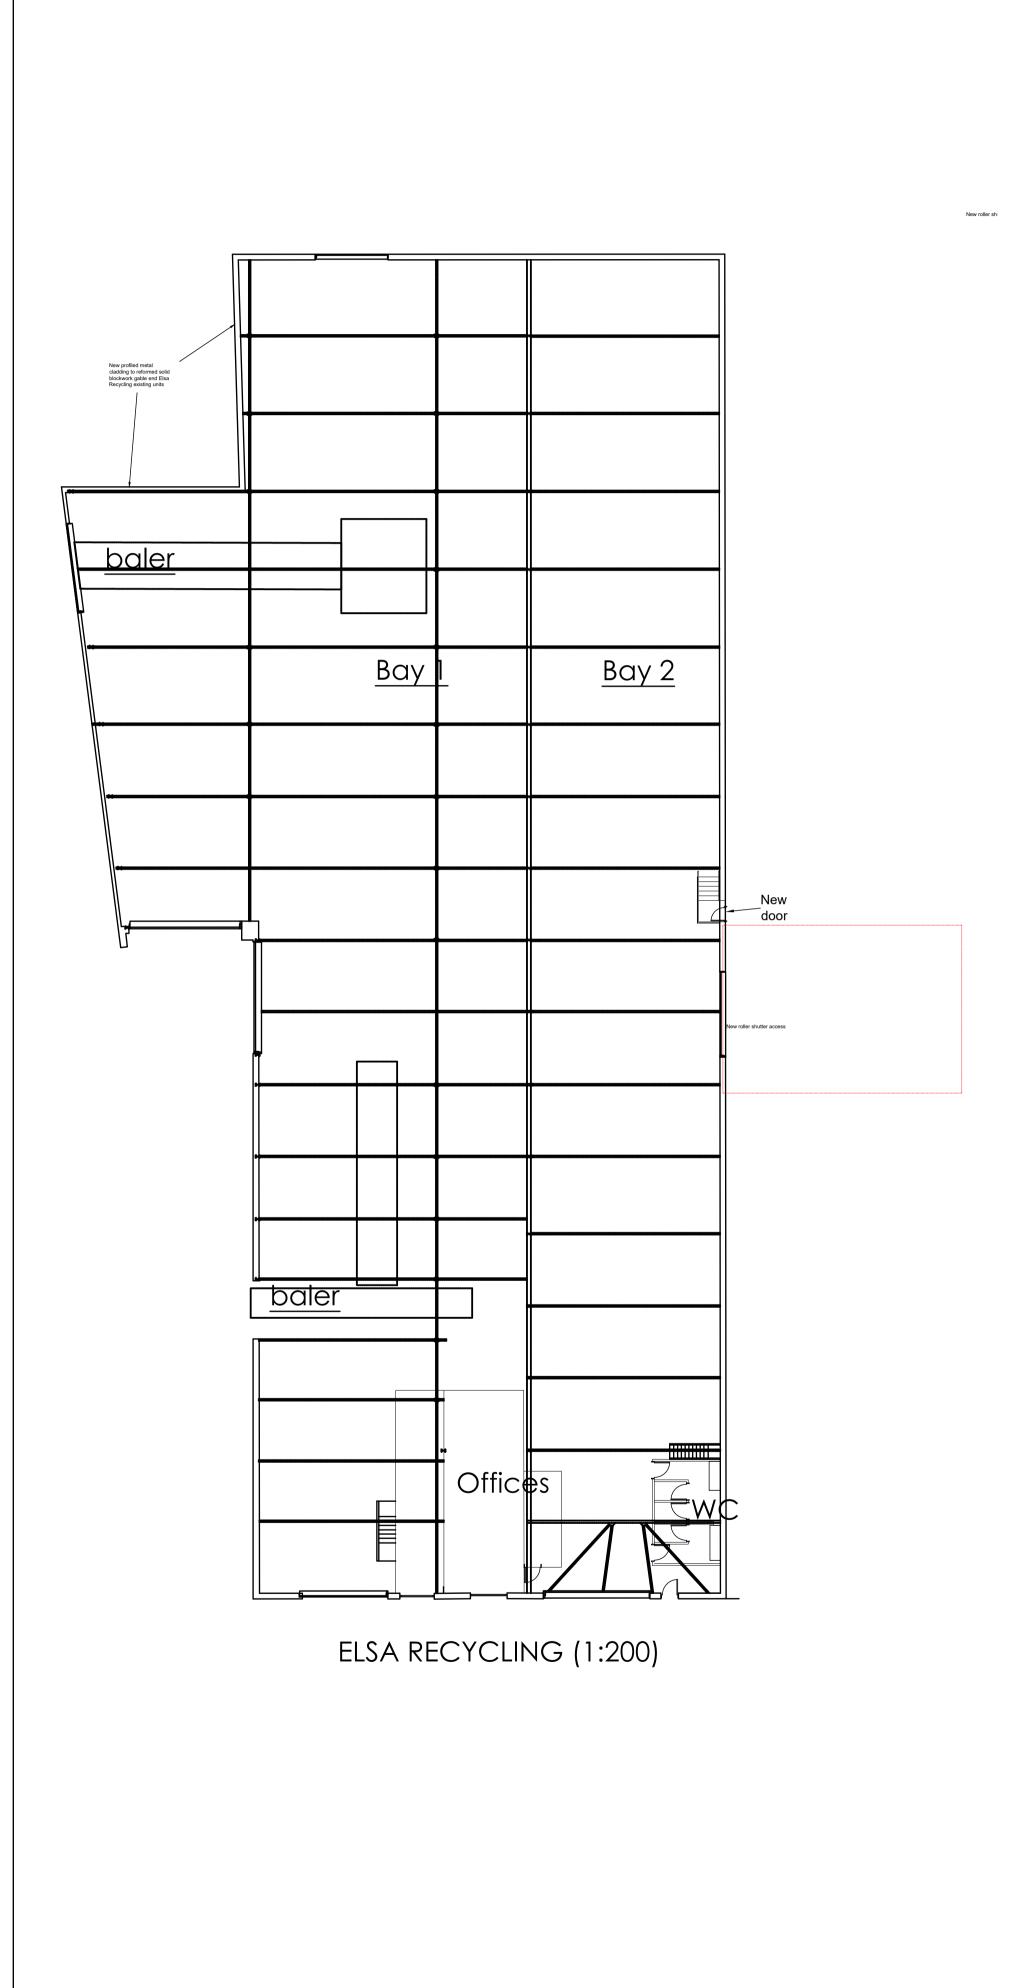

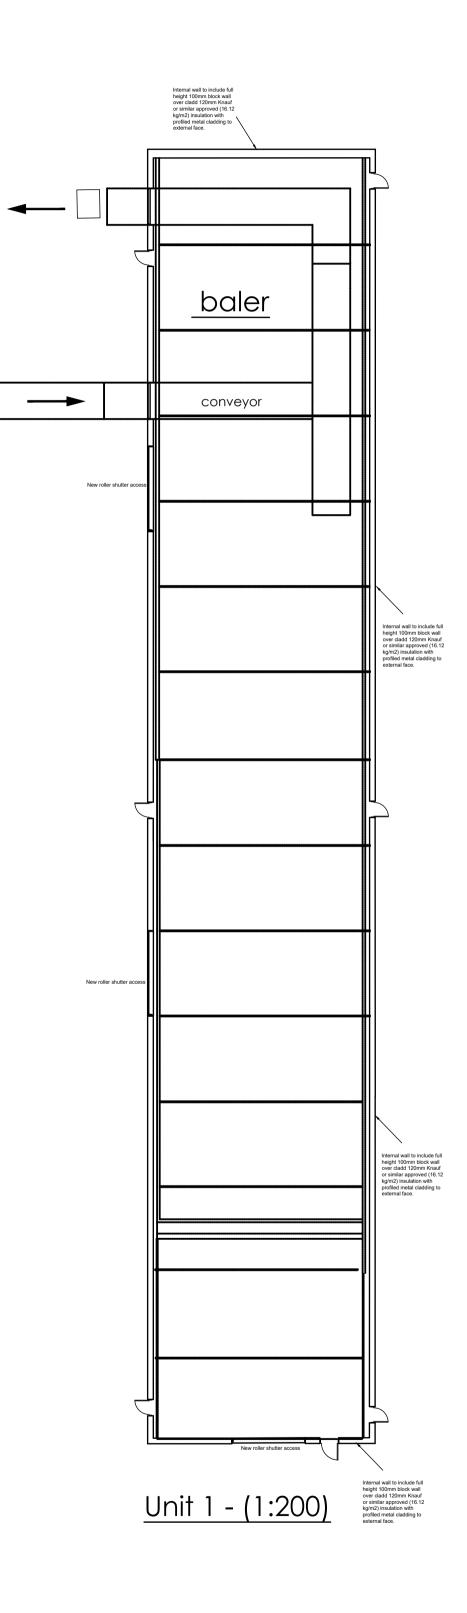



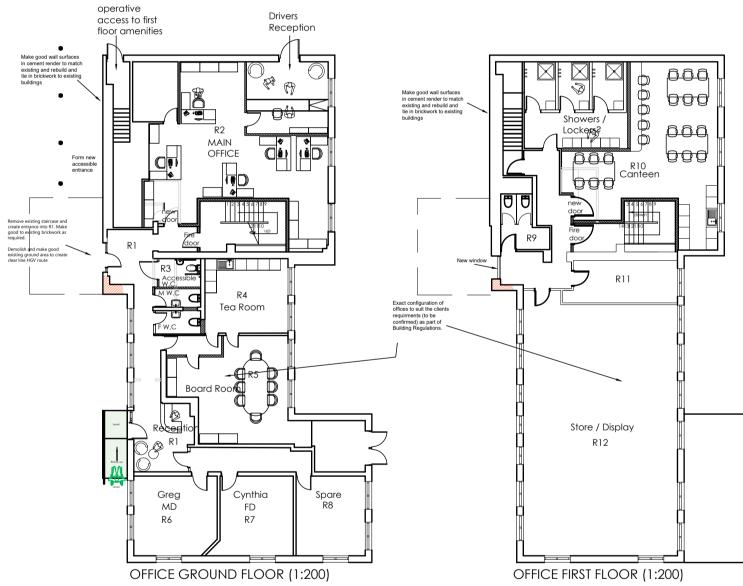


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Rev B:Stair removed to ease v escape stair added.	ehicle access. N	lew	
Rev A: November 2020 :Office access, showers, w.c's, and re to 1:200.	•	•	
Client: Elsa Recycling Group Units 1 - 3 Station Road Station Road Industrial Estate Stockport SK5 6ND			
Property Address: Units 1 - 3 Station Road Station Road Industrial Estate Stockport SK5 6ND			
DWG Reference:	Job Numbe	<u>r:</u>	
269 - DWG	269		
Scale:	DWG Number:		
As Shown on A1	012		
Job Description:	Date:		
Site Reconfiguration	1st February 2019		
DWG Title:	Drawn:	Checked:	
PROPOSED FLOOR PLAN	LPM	PWM	



ROOF PLAN AS PROPOSED

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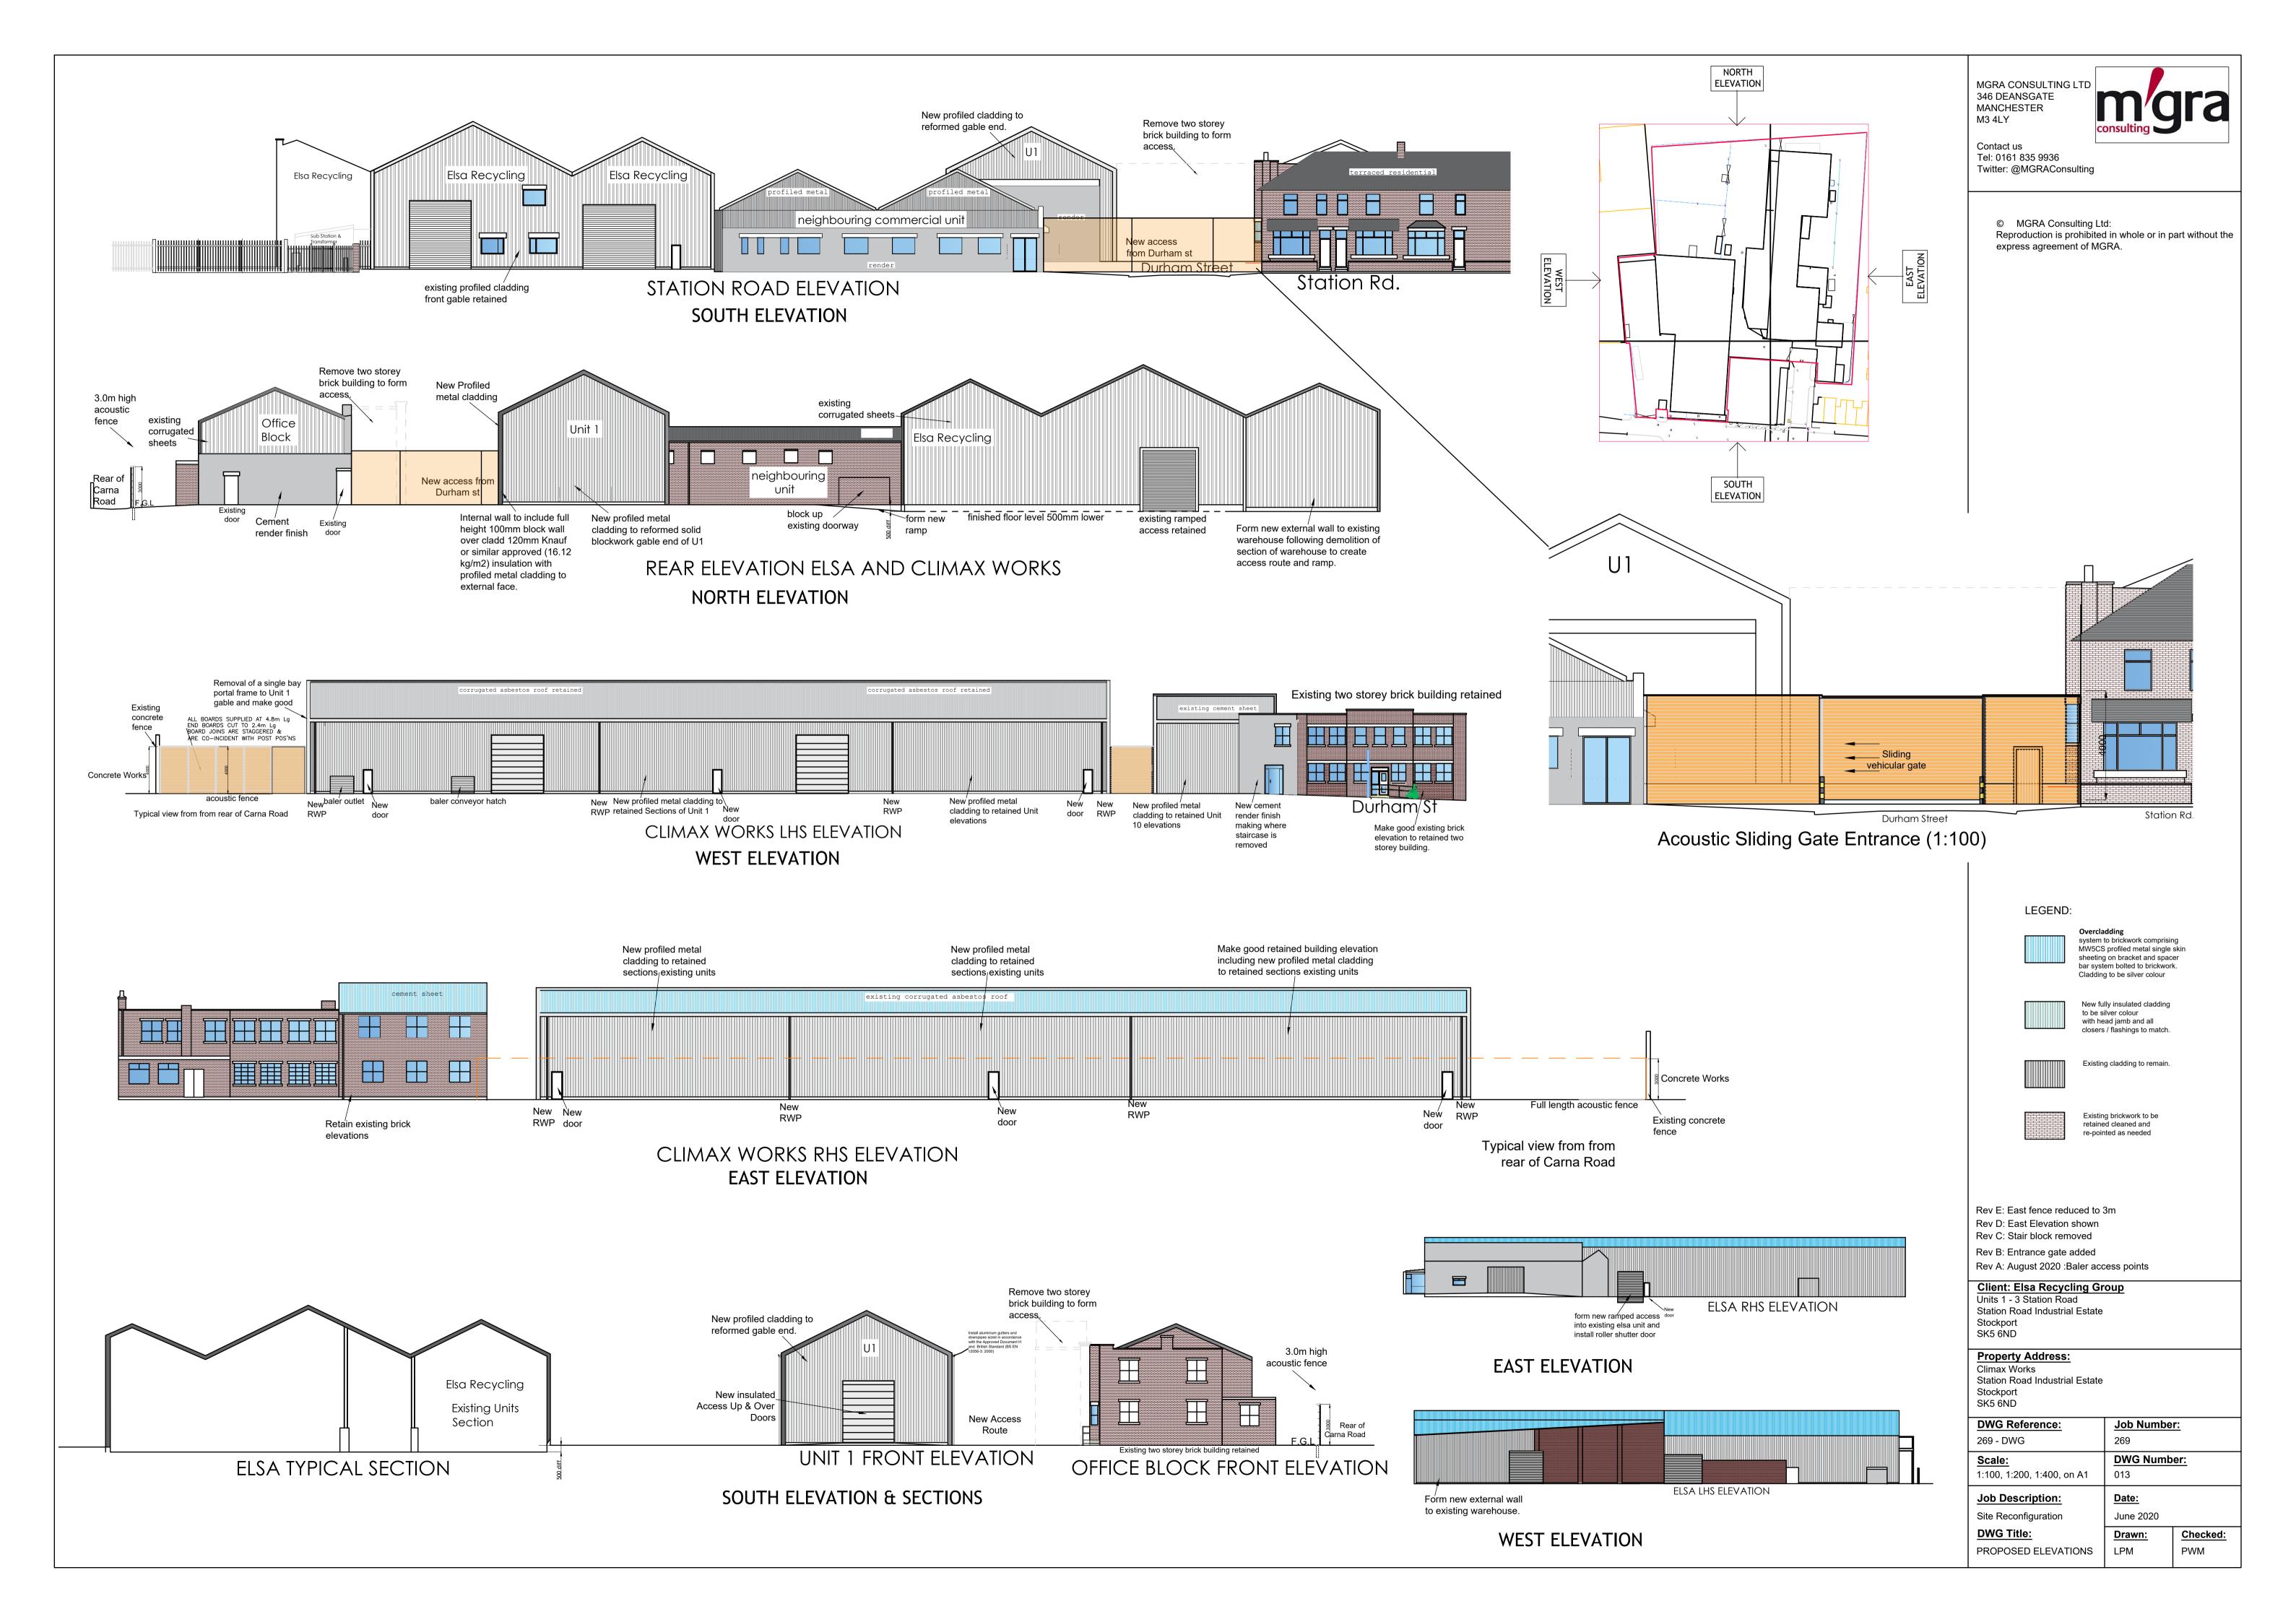
346 DEANSGATE MANCHESTER M3 4LY

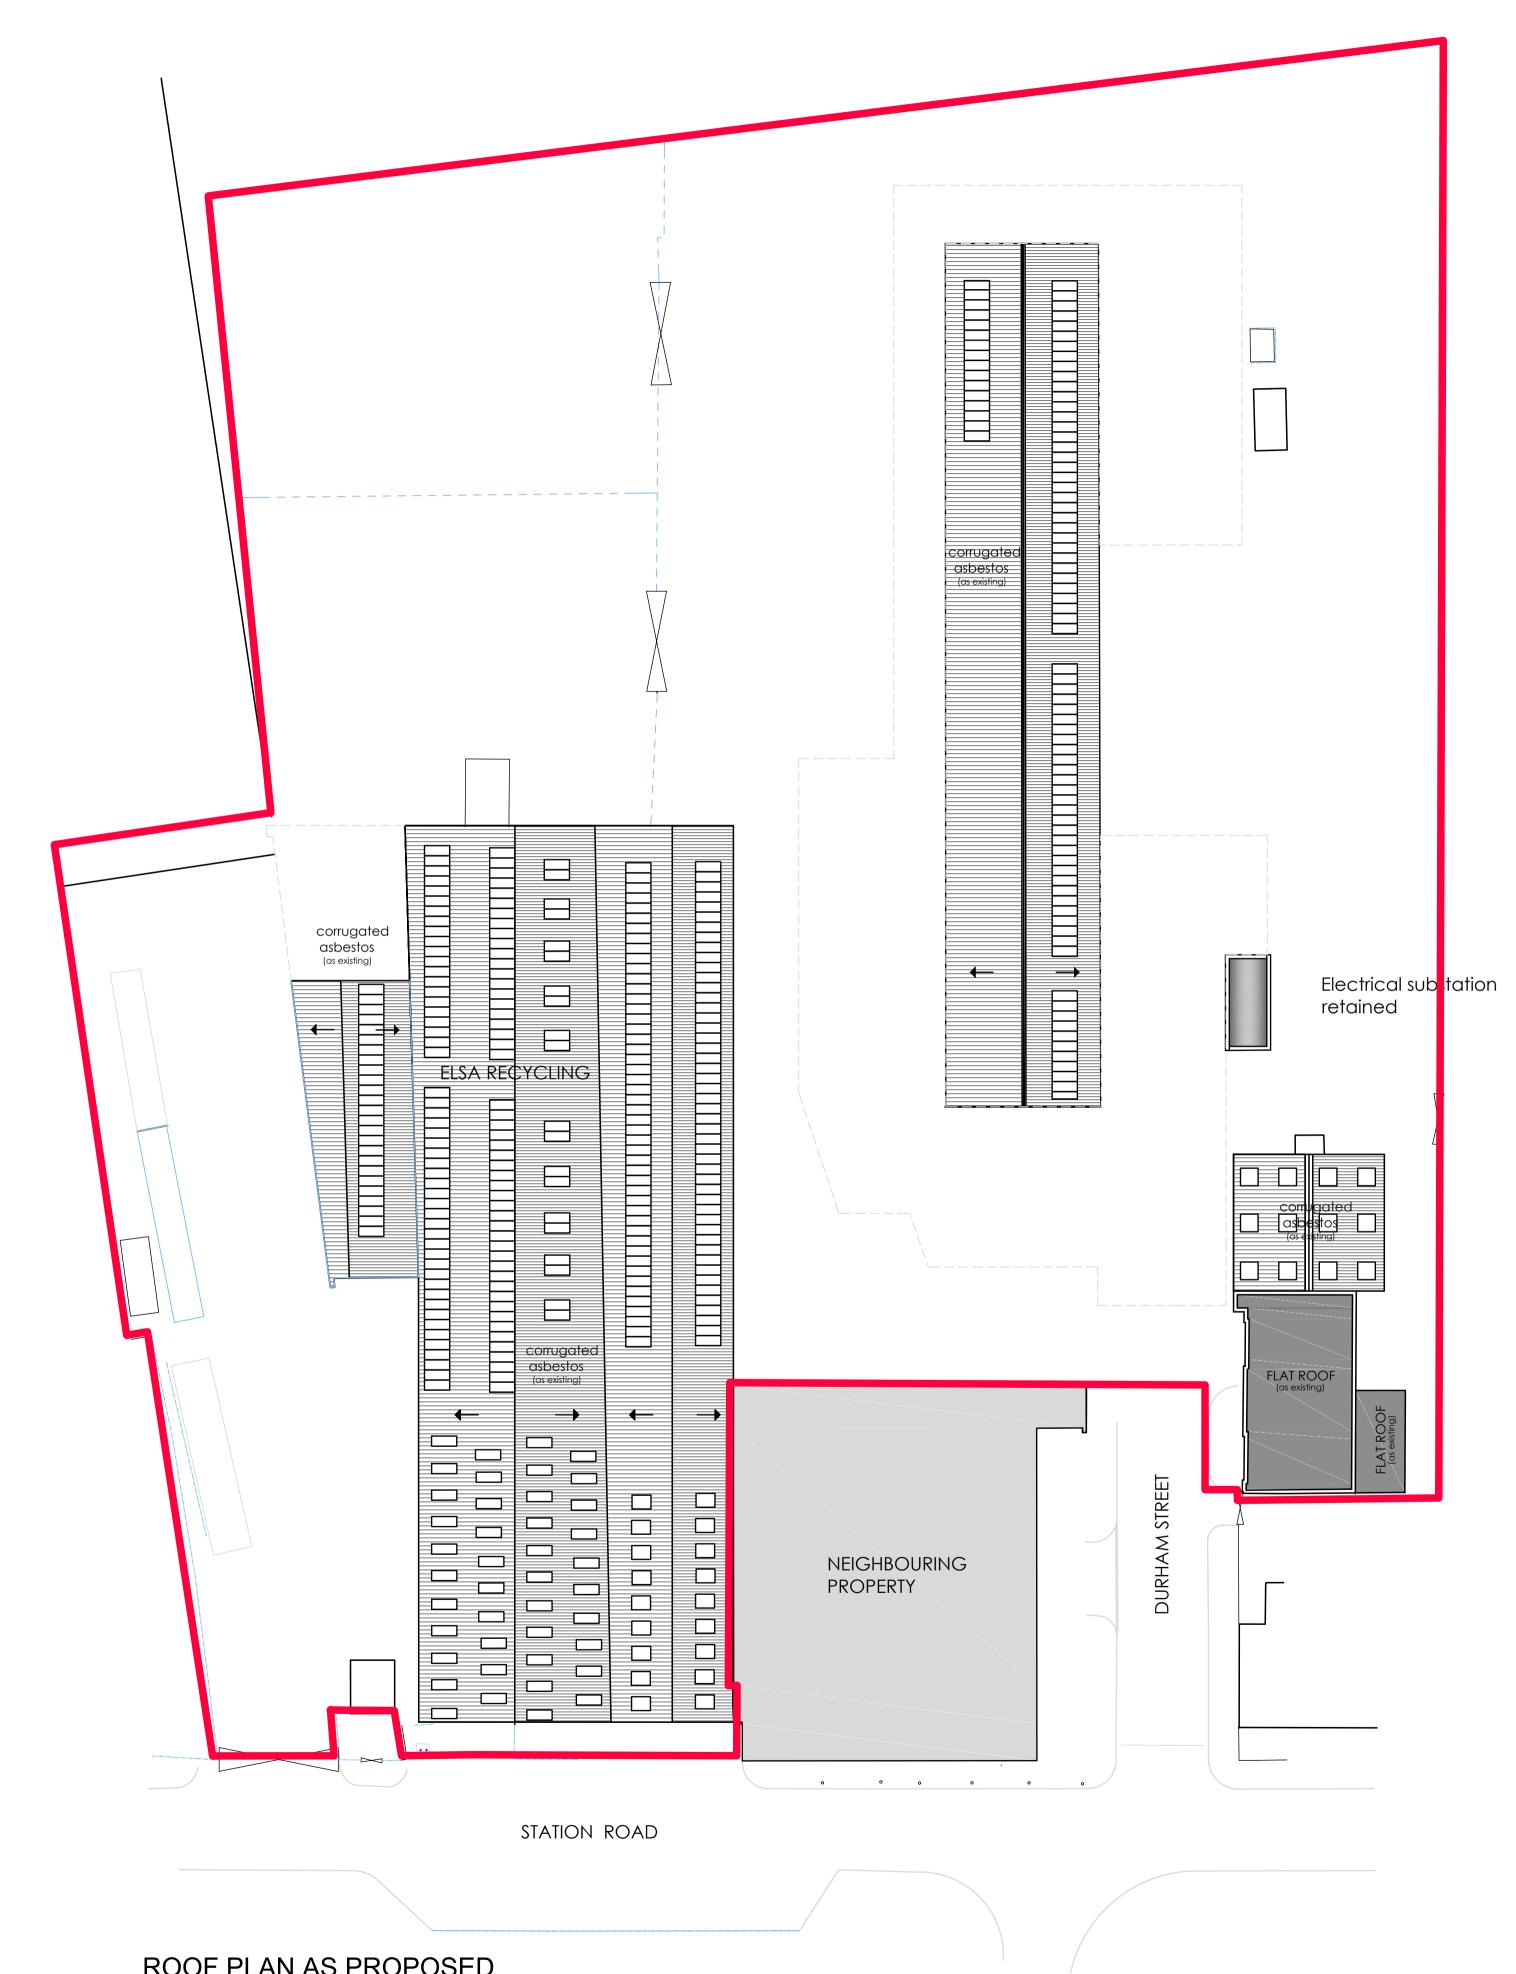



## Contact us Tel: 0161 835 9936 Twitter: @MGRAConsulting email: CAD@mgra.co.uk

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Client: Elsa Recycling Gr Units 1 - 3 Station Road	oup		
Station Road Industrial Estate Stockport			
SK5 6ND			
Property Address:			
Units 1 - 3 Station Road Station Road Industrial Estate			
Stockport SK5 6ND			
DWG Reference:	Job Numbe	<u>r:</u>	
269 - DWG	269		
Scale:	DWG Numb	er:	
1:300 on A1	009		
Job Description:	<u>Date:</u>		
Site Reconfiguration	December 2020		
DWG Title:	<u>Drawn:</u>	<u>Checked:</u>	
Proposed Roof Plan	LPM	PWM	





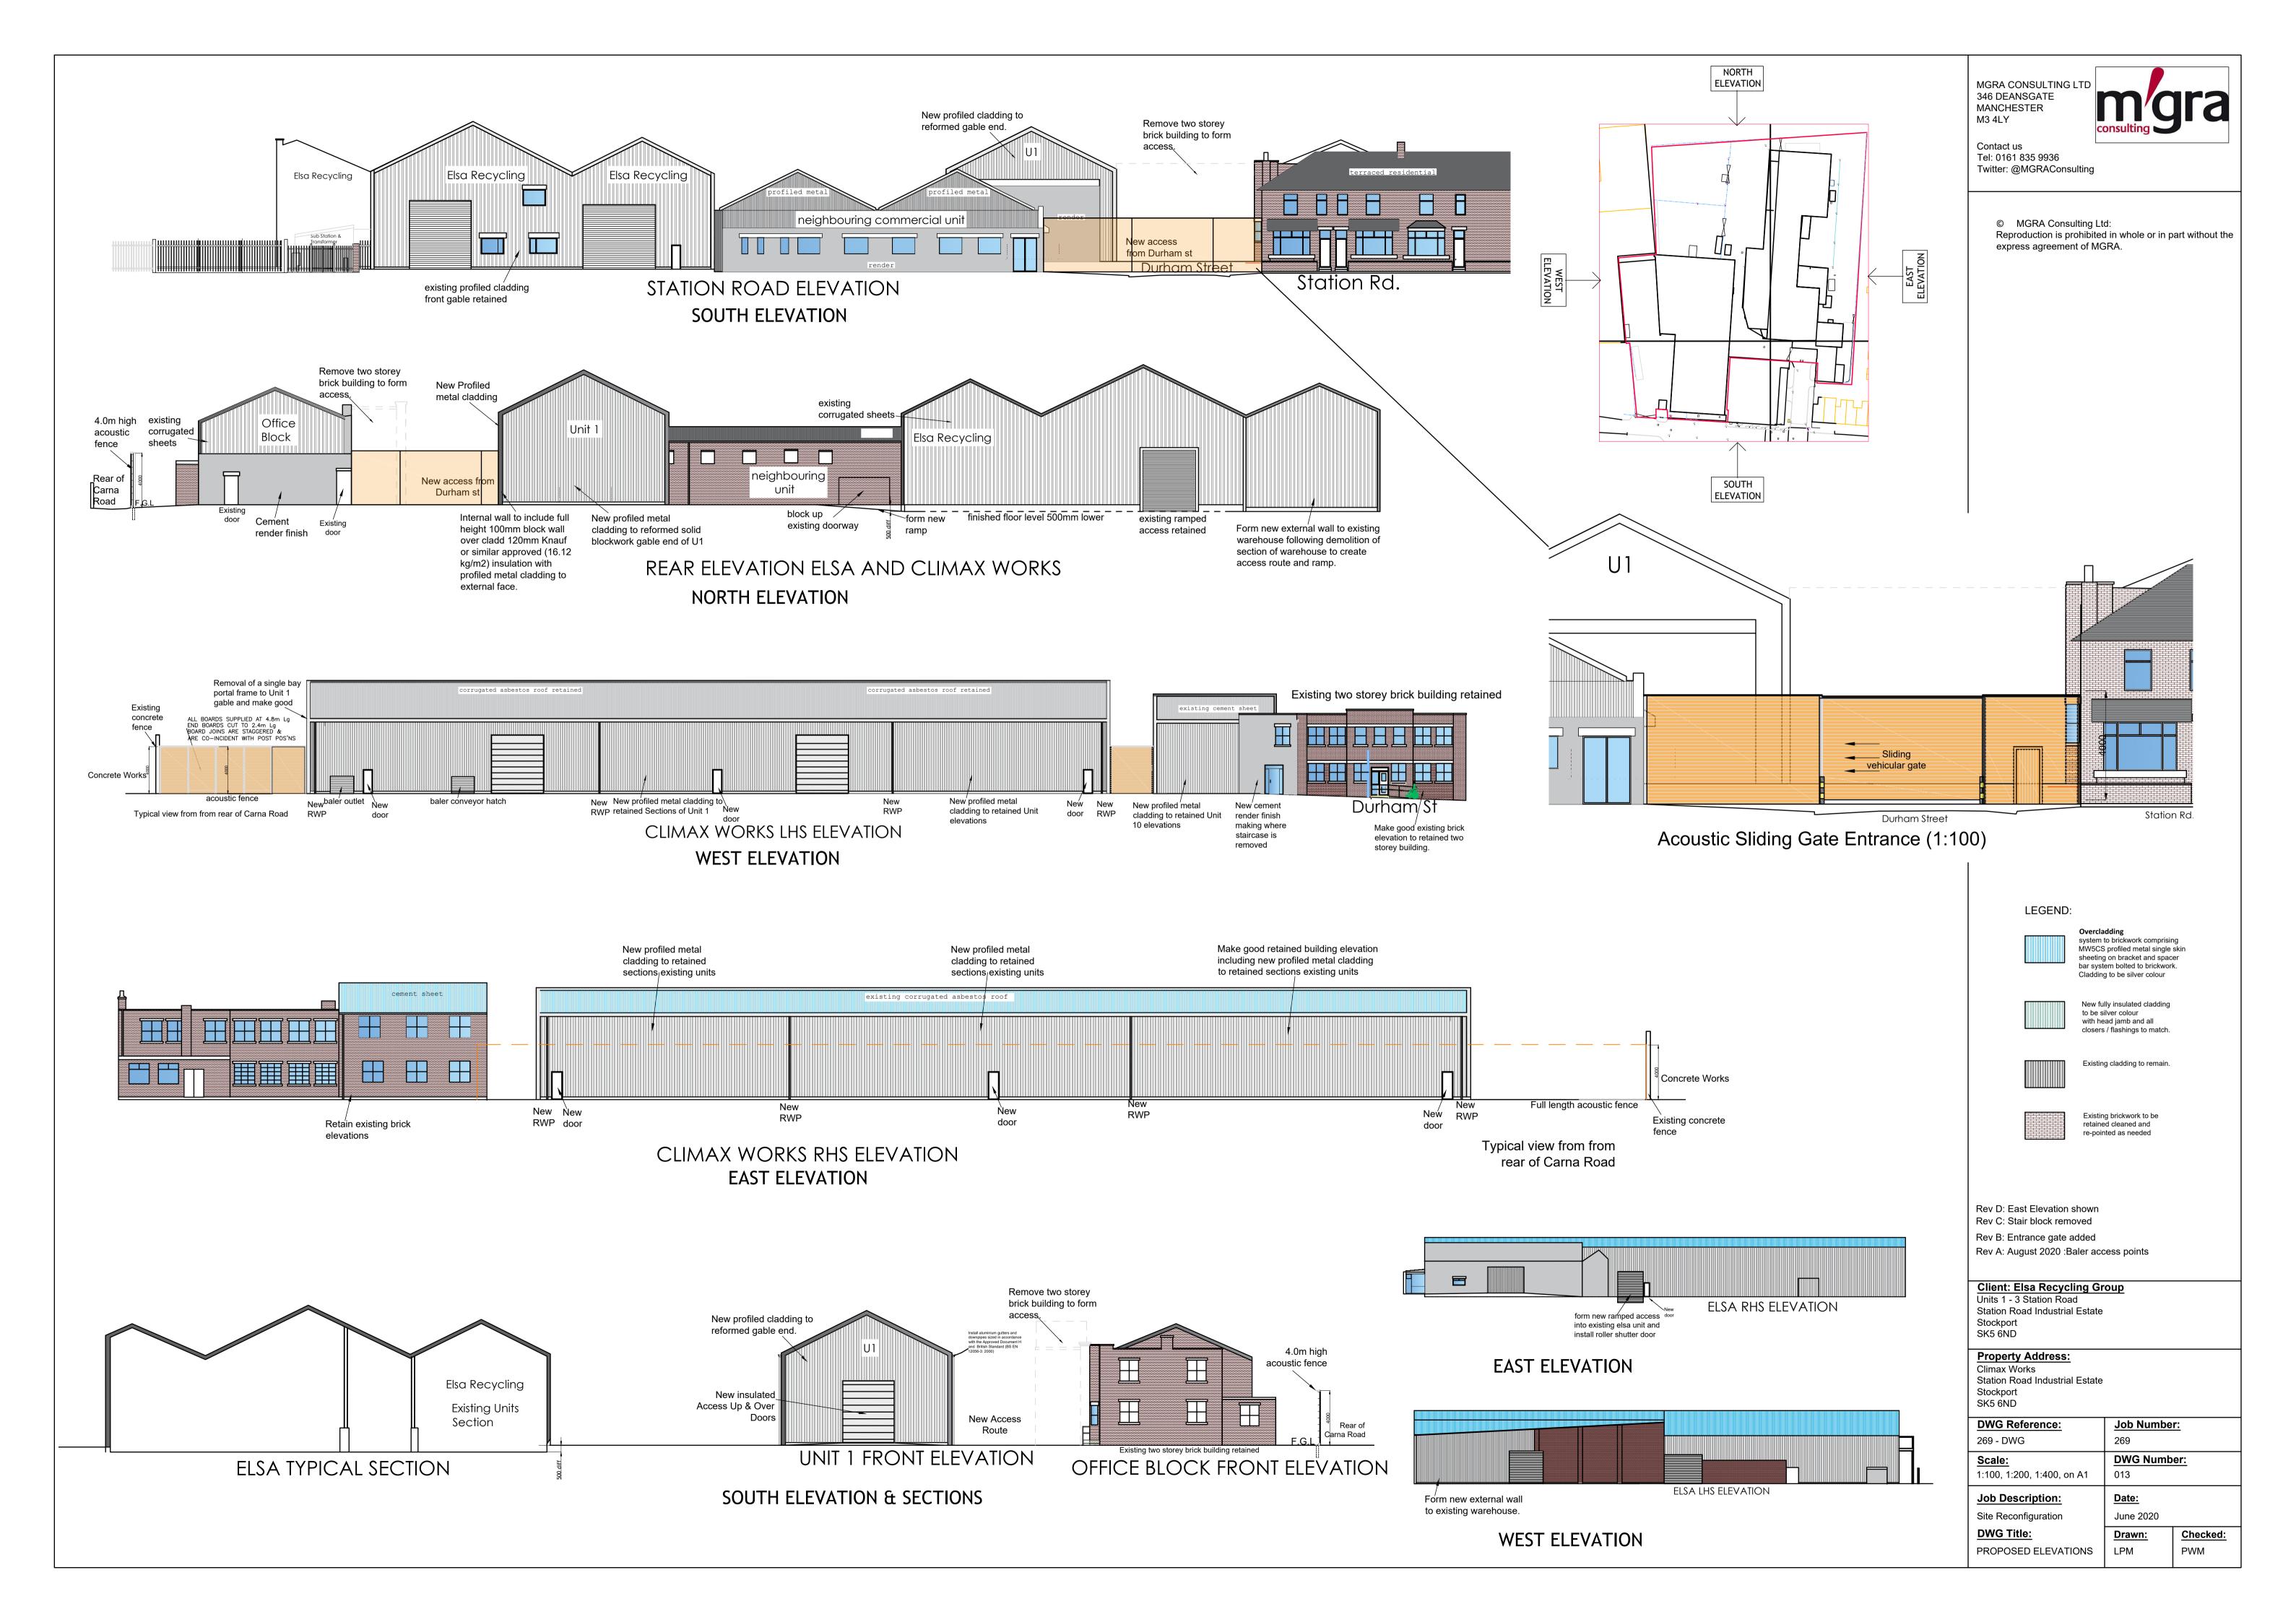

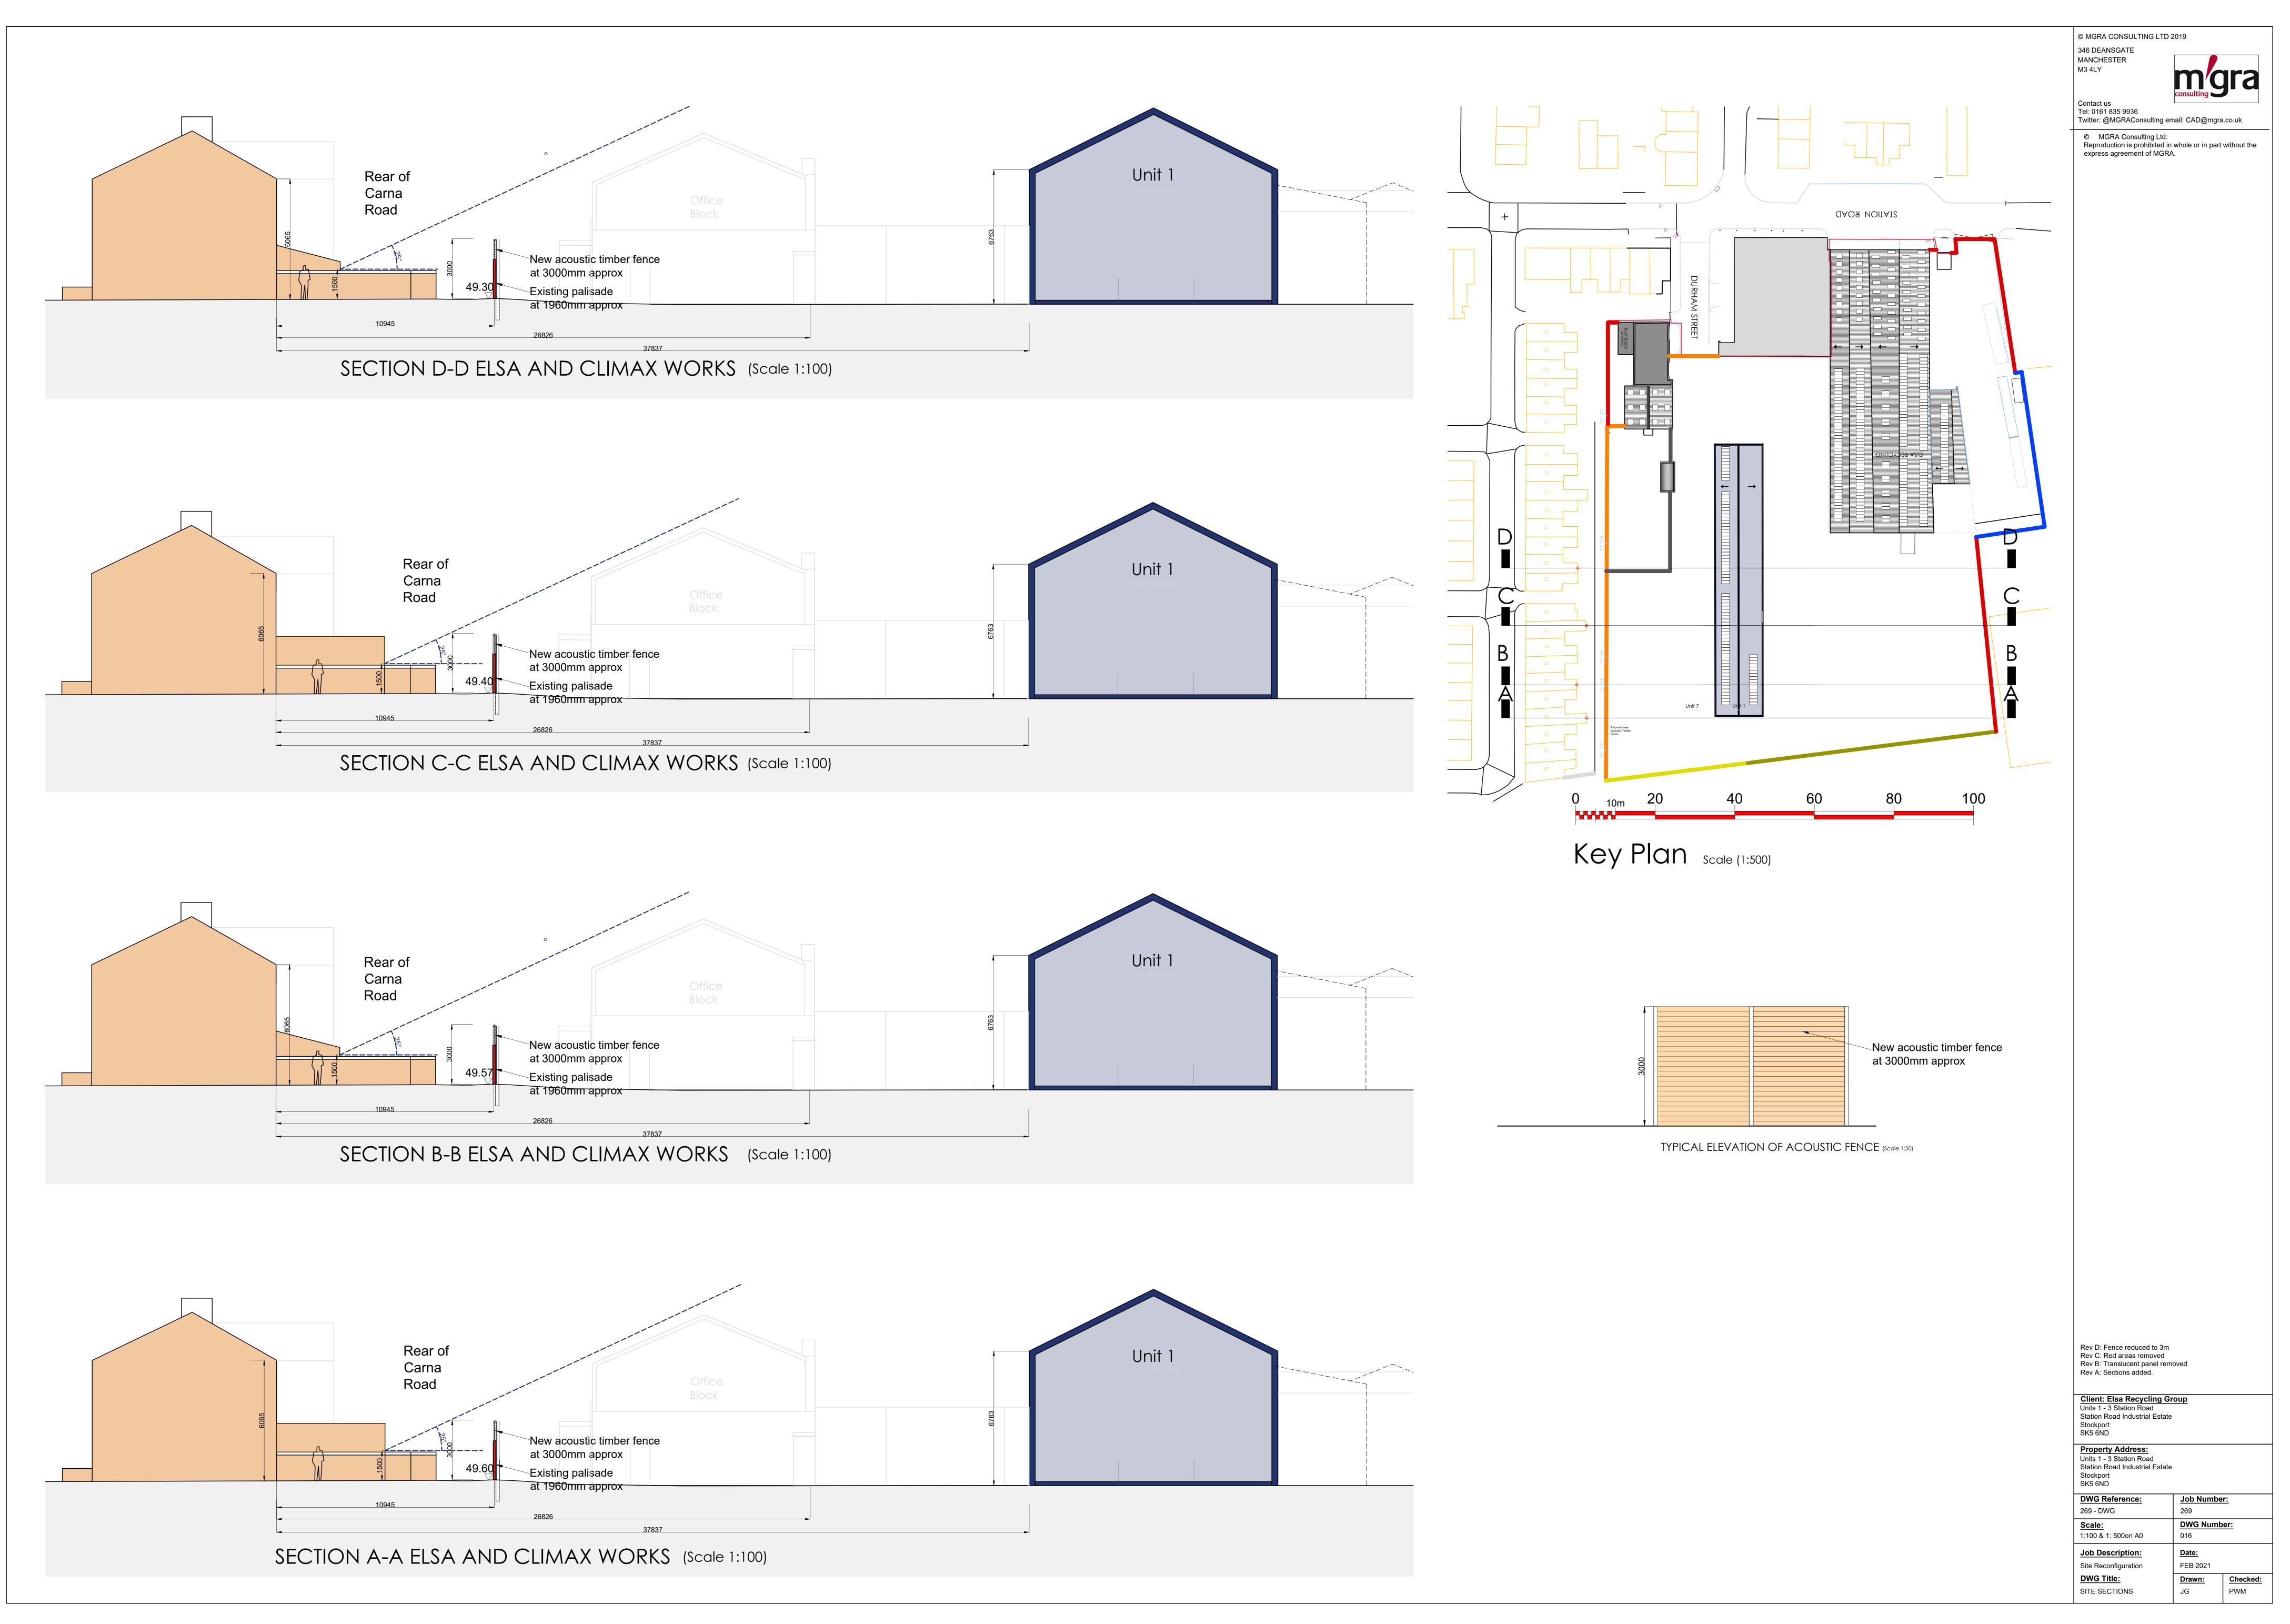Job Description: MGRA Consulting Ltd: C Reproduction is prohibited in whole or in part without the Site Reconfiguration express agreement of MGRA. **DWG Title:** Contact us Unit 1 Typical Section Tel: 0161 835 9936 Retain existing corrugated Install aluminium gutters and asbestos sheets, make downpipes sized in accordance good damaged sheets. with the Approved Document H Install aluminium gutters and and British Standard (BS EN Remarke internal 12056-3: 2000) terboard soffit line downpipes sized in accordance nla with the Approved Document H nels from the undersi and British Standard (BS EN roof. 12056-3: 2000) NEW Profiled metal cladding to external face 100mm Concrete Block 100mm Concrete Block full height to underside of full hieght to underside of eaves, including retain the eaves existing internal blockwork NEW Profiled metal

and increase height where

necessary.

120mm thick 17.92 kg/m2

VAPOUR CONTROL

Rockwool

LAYER

DWG Reference: 269 - DWG	<mark>Job Number:</mark> 269	Property Address: Climax Works Station Road Industrial Estate	Client: Elsa Recycling Group Units 1 - 3 Station Road	<u>Date:</u> May 2020		mara	
<u>Scale:</u> 1:200 on A1	DWG Number: 014	Stockport SK5 6ND	Station Road Industrial Estate Stockport SK5 6ND	<u>Drawn:</u> LPM	Checked: PWM		

6.25m

cladding to external face

120mm thick 17.92 kg/m2

VAPOUR CONTROL

Rockwool

LAYER