







**NOTES**

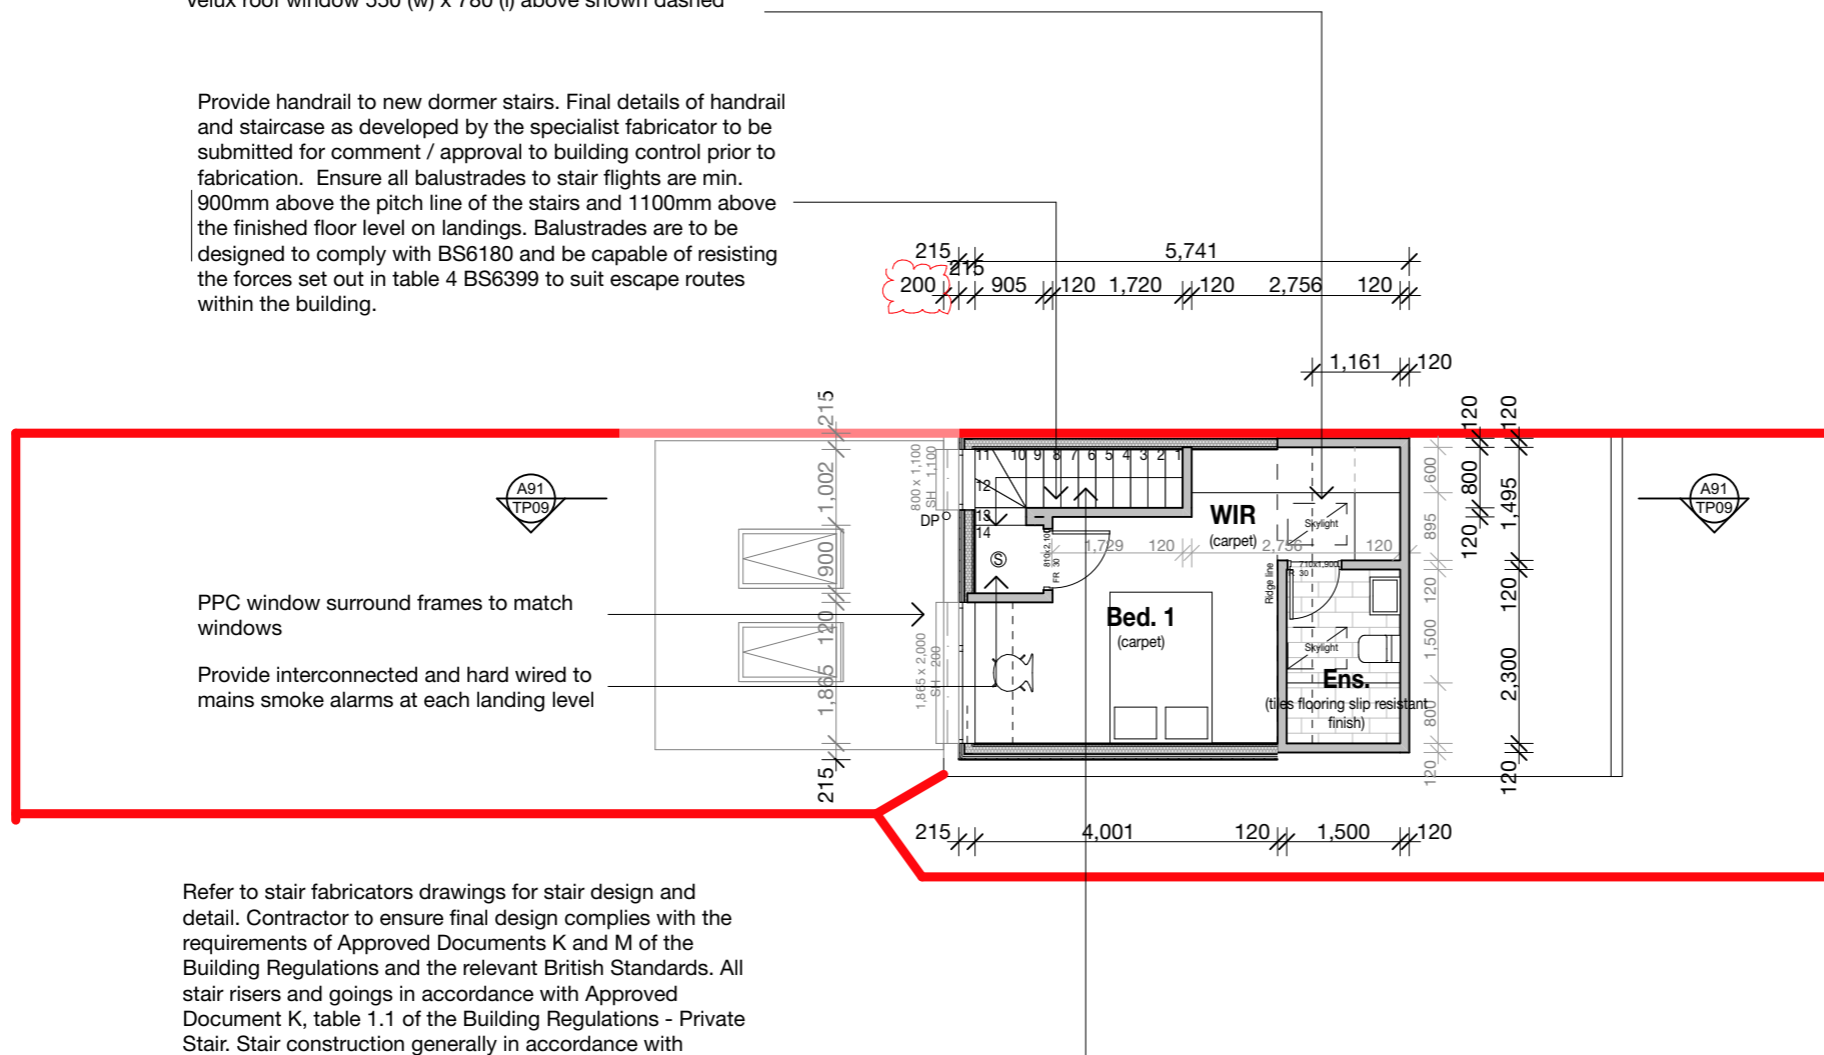
Do not scale this drawing. All dimensions are to be verified on site and any discrepancies reported before commencement of any work or shop drawings.

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Issue/ Rev #	Description	Date
#	Initial Issue	30.06.20
A	Amendment A - dormer set back increased to 200mm from eaves and slate colour changed to dark at the request of SCC	06.09.20

Velux roof window 550 (w) x 780 (l) above shown dashed

Provide handrail to new dormer stairs. Final details of handrail and staircase as developed by the specialist fabricator to be submitted for comment / approval to building control prior to fabrication. Ensure all balustrades to stair flights are min. 900mm above the pitch line of the stairs and 1100mm above the finished floor level on landings. Balustrades are to be designed to comply with BS6180 and be capable of resisting the forces set out in table 4 BS6399 to suit escape routes within the building.



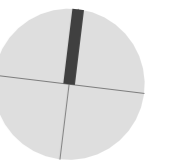
PPC window surround frames to match windows

Provide interconnected and hard wired to mains smoke alarms at each landing level

Refer to stair fabricators drawings for stair design and detail. Contractor to ensure final design complies with the requirements of Approved Documents K and M of the Building Regulations and the relevant British Standards. All stair risers and goings in accordance with Approved Document K, table 1.1 of the Building Regulations - Private Stair. Stair construction generally in accordance with Approved Document K, Section 1: Stairs and ladder:

Rise – Min. 150mm                      Max. 220mm  
 Going - Min. 220mm                    Max. 300mm  
 Max pitch for stairs is 42°

**Proposed Loft Plan**



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**FOR PLANNING/  
 BUILDING CONTROL  
 APPROVAL**

Client  
**Porter Property Investments**

Project Description  
**12 Seymour Road, Cheadle**

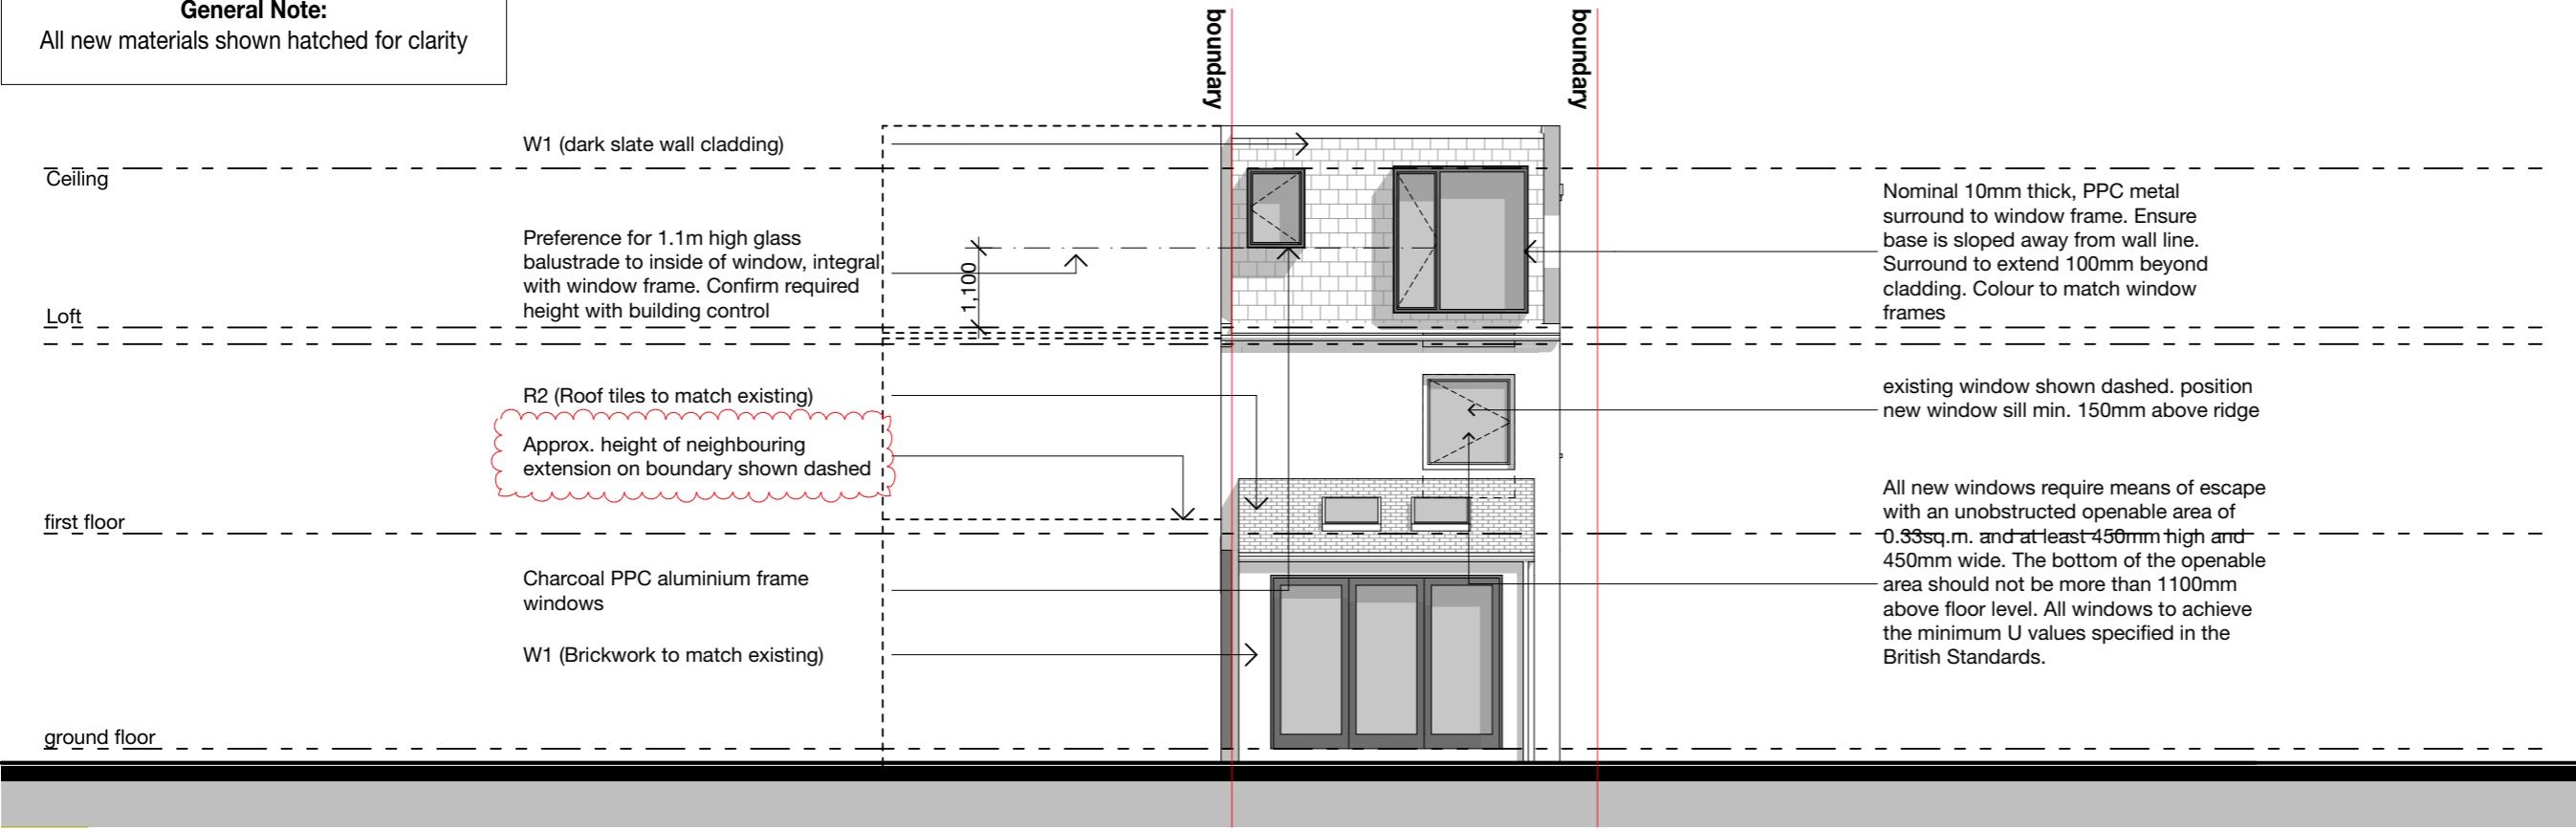
Project Number **SEY012**  
 Drawing Title

**Plans - Proposed Loft Plan**

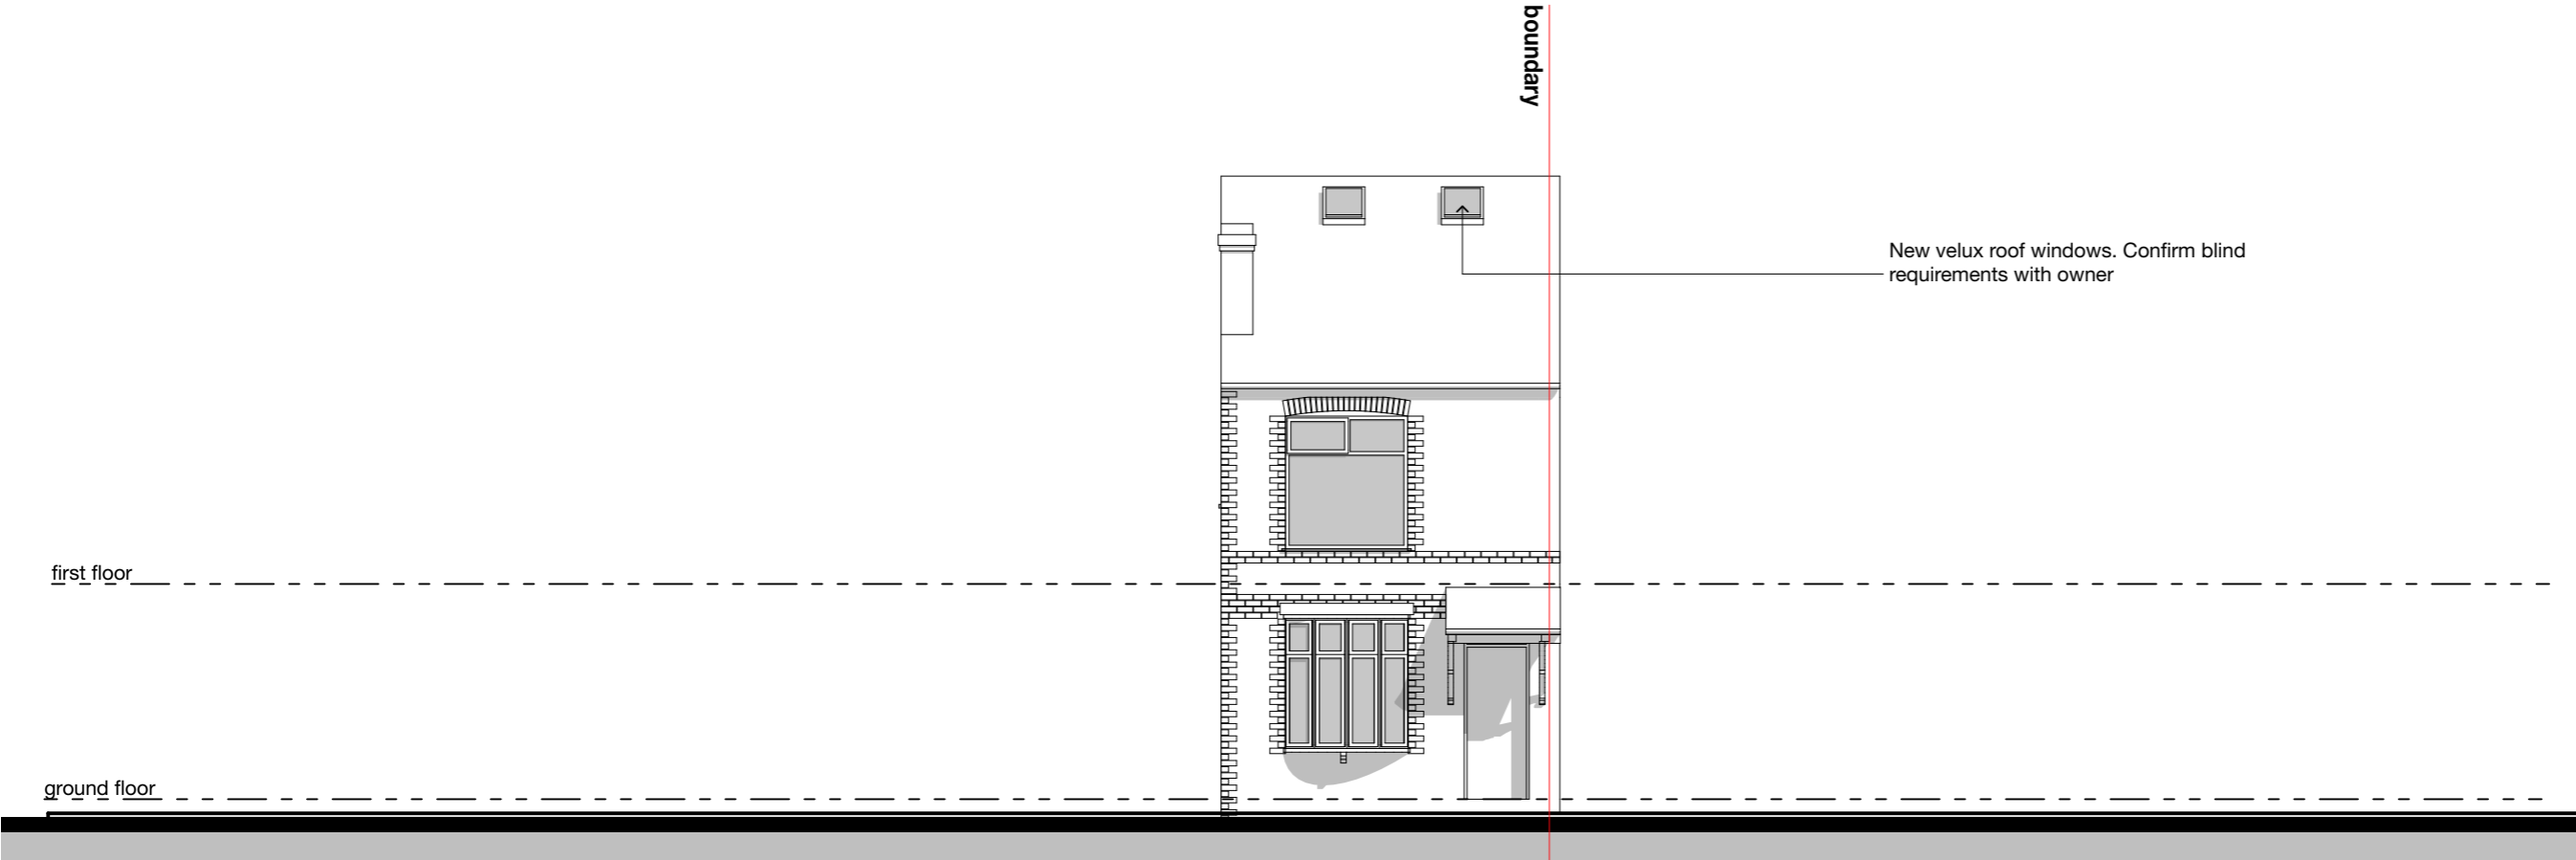
Drawing Number                      Scale  
**TP06                                      1:100 @ A3**



**General Note:**  
All new materials shown hatched for clarity



East Elevation - Proposed



West Elevation - Proposed

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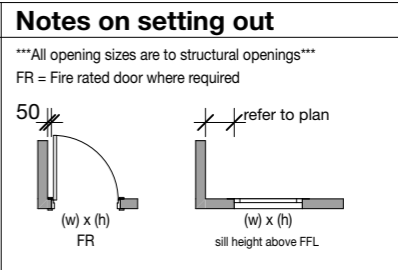
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Issue/ Rev	Description	Date
#	Initial Issue	30.06.20
A	Amendment A - dormer set back increased to 200mm from eaves and slate colour changed to dark at the request of SCC	06.09.20
B	Amendment B - Approx. height of neighbouring extension added to plans at the request of SCC	21.09.20

Legend					
ref.	Refrigerator	st	Store	R1	Roof Type 1
wo.	Wall oven	wir	Walk in wardrobe	DP	Downpipe
dw	Dishwasher	hc	Hosecock	OP	Overflow pop
shr.	Shower	W1	Wall type 1	HOP	Hopper
s	Sink	W2	Wall type 2	FG	Floor gully
t	Laundry tub	PS	plumbing stack	WIR	Walk in wardrobe
vb	Vanity basin	MF	metal flashing		

**Refer to General Notes For Details**  
\*\*\*All structure shown as graphic representation: please refer to structural engineering package for exact details of footings, concrete slab, timber framed floors, wall & roof framing\*\*\*

**Notes**  
- Do not scale this drawing. All dimensions are to be verified on site and any discrepancies reported before commencement of any work or shop drawings  
- All new windows and doors sizes indicated are to structural openings and to be site measured. Window style/detailing and opening sash locations to be confirmed and approved by owner prior to fabrication. All new windows require means of escape with an unobstructed openable area of 0.33sq.m. and at least 450mm high and 450mm wide. The bottom of the openable area should not be more than 1100mm above floor level. All windows to achieve the minimum U values specified in the British Standards.  
- All floors (suspended or on ground) walls and roofs are to be insulated and achieve at least the minimum U values listed under Approved Document Part L of the British Regulations.  
- Confirm all finishes and materials with owner.  
- Provide DPC 150mm min. above natural ground to all masonry walls.  
\*\*\*All works to be constructed in accordance with accredited construction details\*\*\*



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**12 Seymour Road, Cheadle**

Project Number **SEY012**  
Drawing Title

**Elevations - Proposed**

Drawing Number Scale

**TP08 1:100 @ A3**

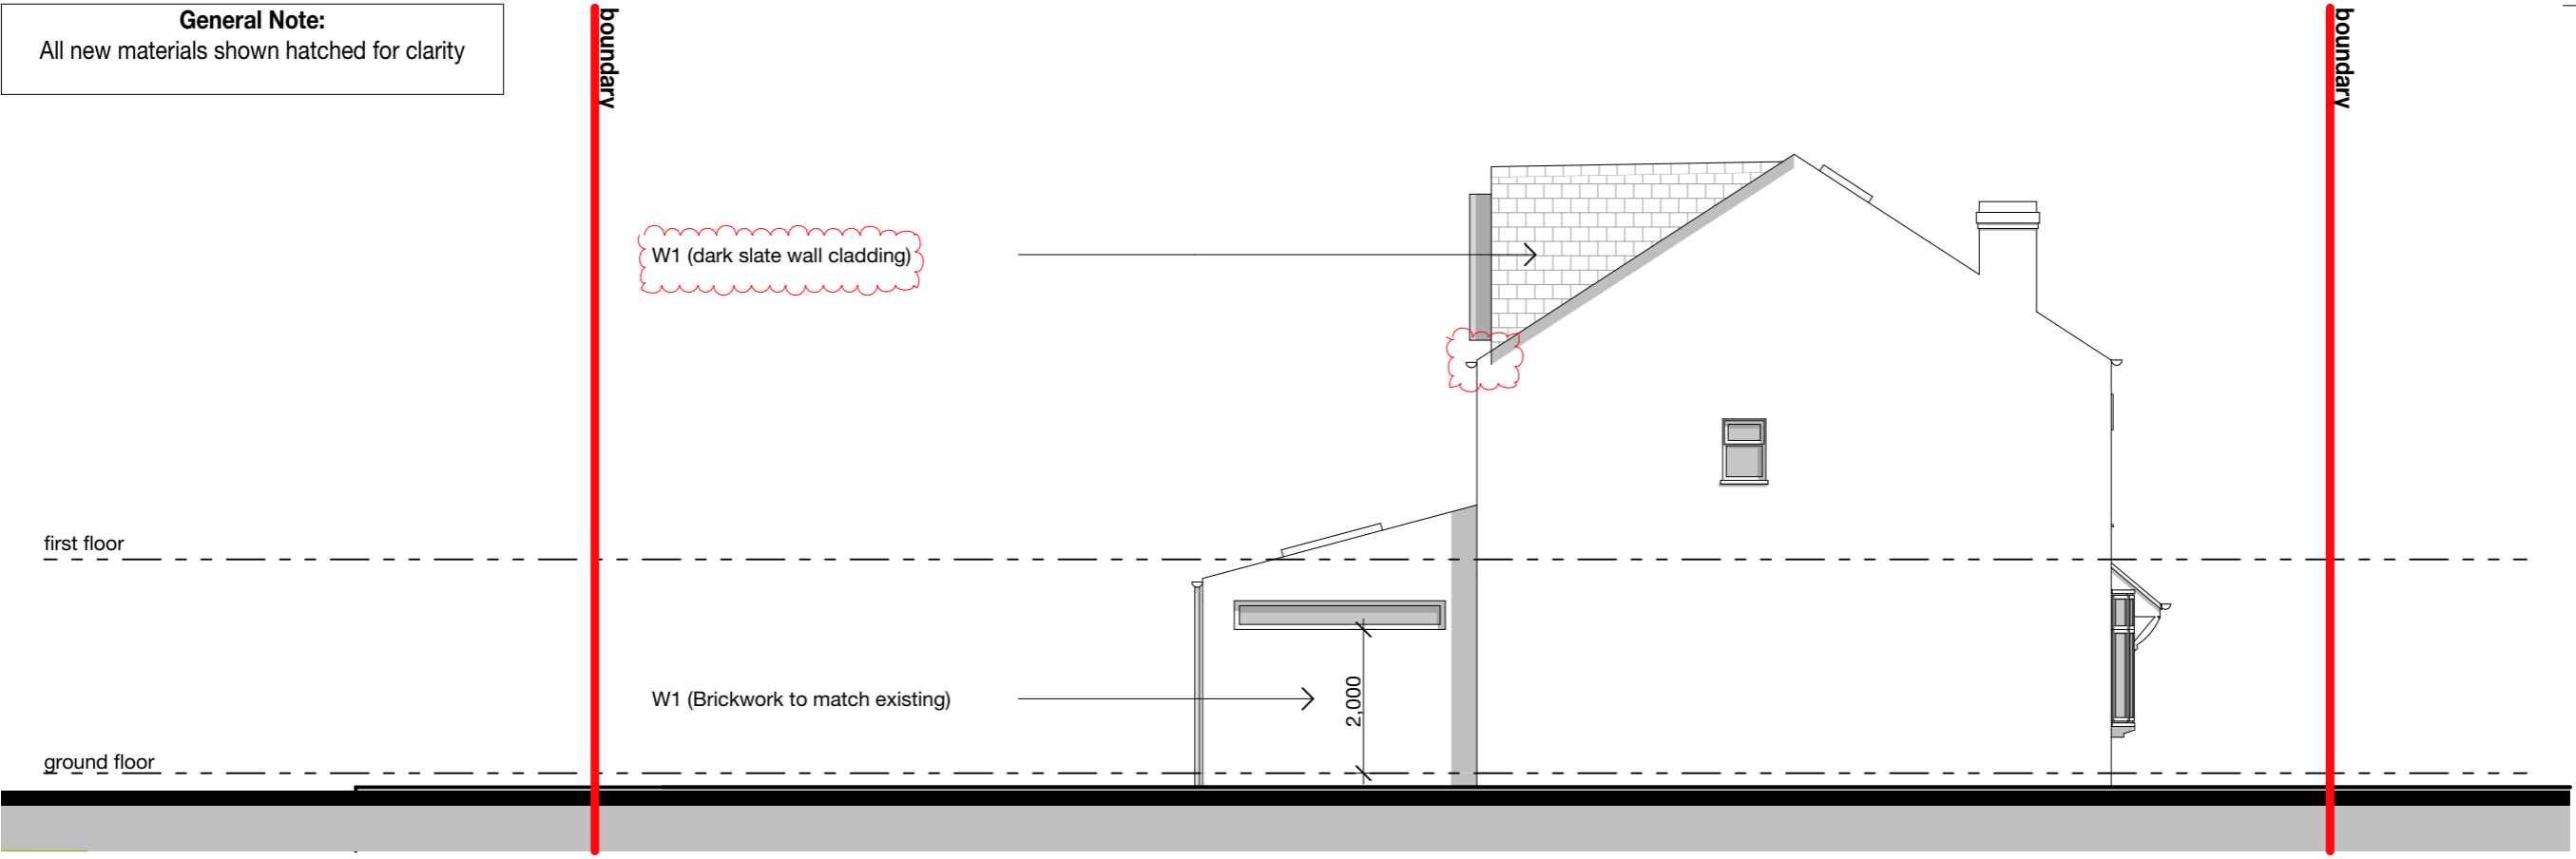


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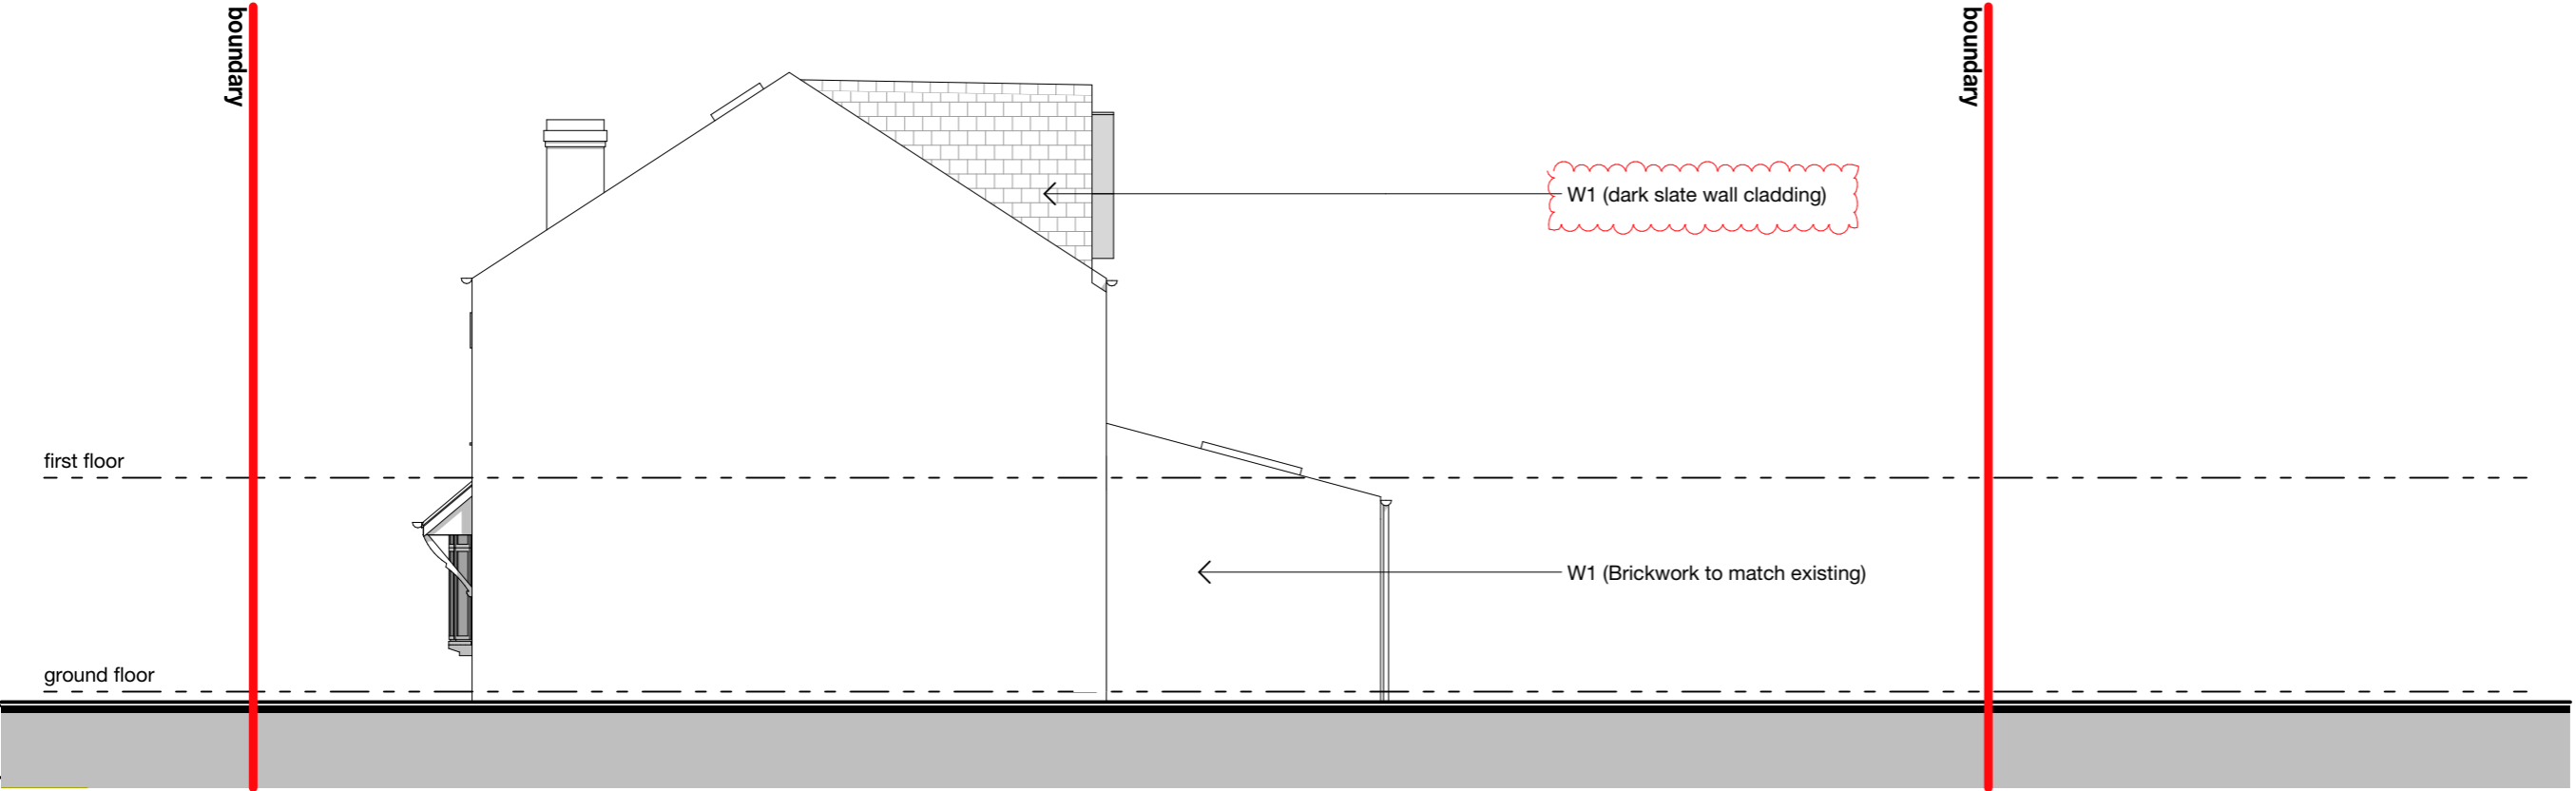
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A	Amendment A - dormer set back increased to 200mm from eaves and slate colour changed to dark at the request of SCC	06.09.20



North Elevation - Proposed



South Elevation - Proposed

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**12 Seymour Road, Cheadle**

Project Number **SEY012**

Drawing Title  
**Elevations - Proposed**

Drawing Number Scale

**TP07 1:100 @ A3**

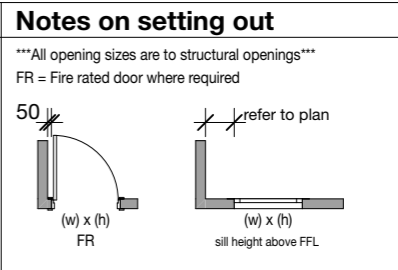
Legend				Refer to General Notes For Details	
ref.	Refrigerator	st	Store	R1	Roof Type 1
wo.	Wall oven	wir	Walk in wardrobe	DP	Downpipe
dw	Dishwasher	hc	Hosecock	OP	Overflow pop
shr.	Shower	W1	Wall type 1	HOP	Hopper
s	Sink	W2	Wall type 2	FG	Floor gully
t	Laundry tub	PS	plumbing stack	WIR	Walk in wardrobe
vb	Vanity basin	MF	metal flashing		

\*\*\*All structure shown as graphic representation: please refer to structural engineering package for exact details of footings, concrete slab, timber framed floors, wall & roof framing\*\*\*

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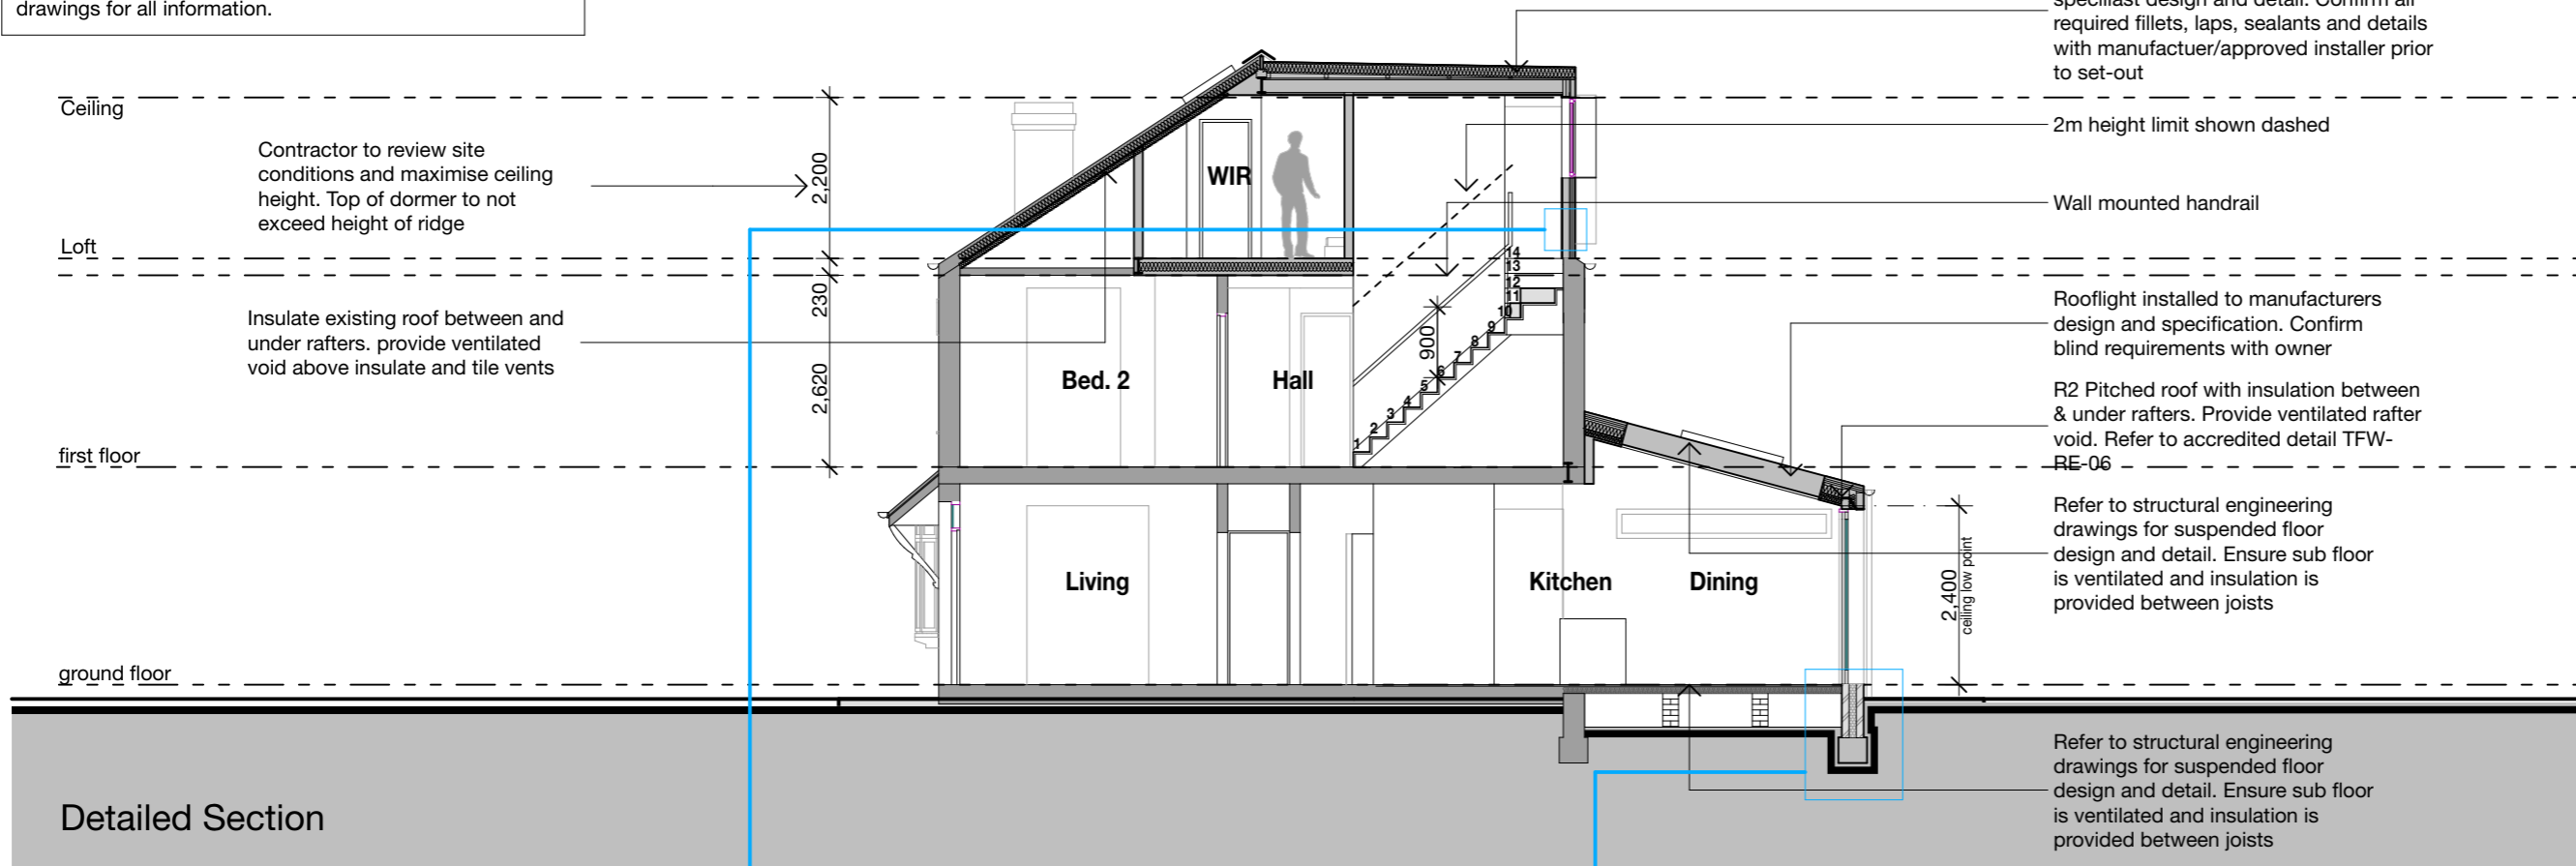
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\*\*\*\*NOTE\*\*\*\*

- perspectives are provided for visual aid only. Refer to drawings for all information.



R1 Mechanically fixed, single ply roof membrane system (Sarnafil or similar) to specialist design and detail. Confirm all required fillets, laps, sealants and details with manufacturer/approved installer prior to set-out

2m height limit shown dashed

Wall mounted handrail

Rooflight installed to manufacturers design and specification. Confirm blind requirements with owner

R2 Pitched roof with insulation between & under rafters. Provide ventilated rafter void. Refer to accredited detail TFW-RE-06

Refer to structural engineering drawings for suspended floor design and detail. Ensure sub floor is ventilated and insulation is provided between joists

Refer to structural engineering drawings for suspended floor design and detail. Ensure sub floor is ventilated and insulation is provided between joists

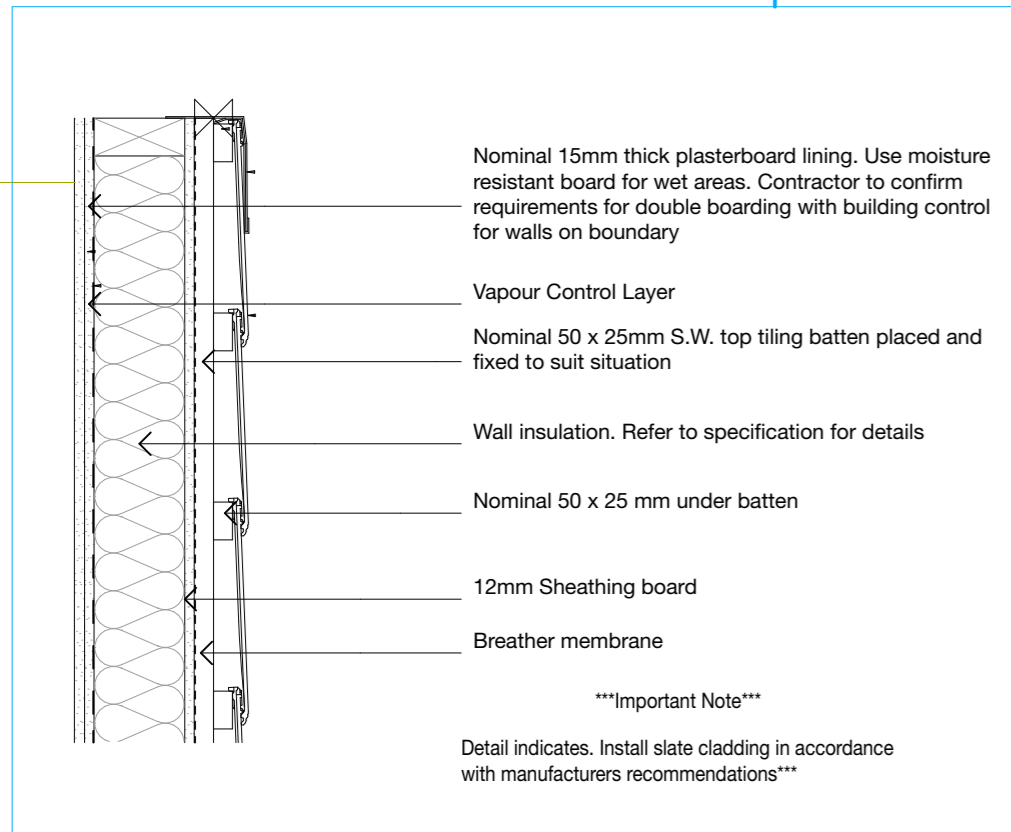
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Issue/ Rev	Description	Date
#	Initial Issue	30.06.20

Detailed Section



Nominal 15mm thick plasterboard lining. Use moisture resistant board for wet areas. Contractor to confirm requirements for double boarding with building control for walls on boundary

Vapour Control Layer

Nominal 50 x 25mm S.W. top tiling batten placed and fixed to suit situation

Wall insulation. Refer to specification for details

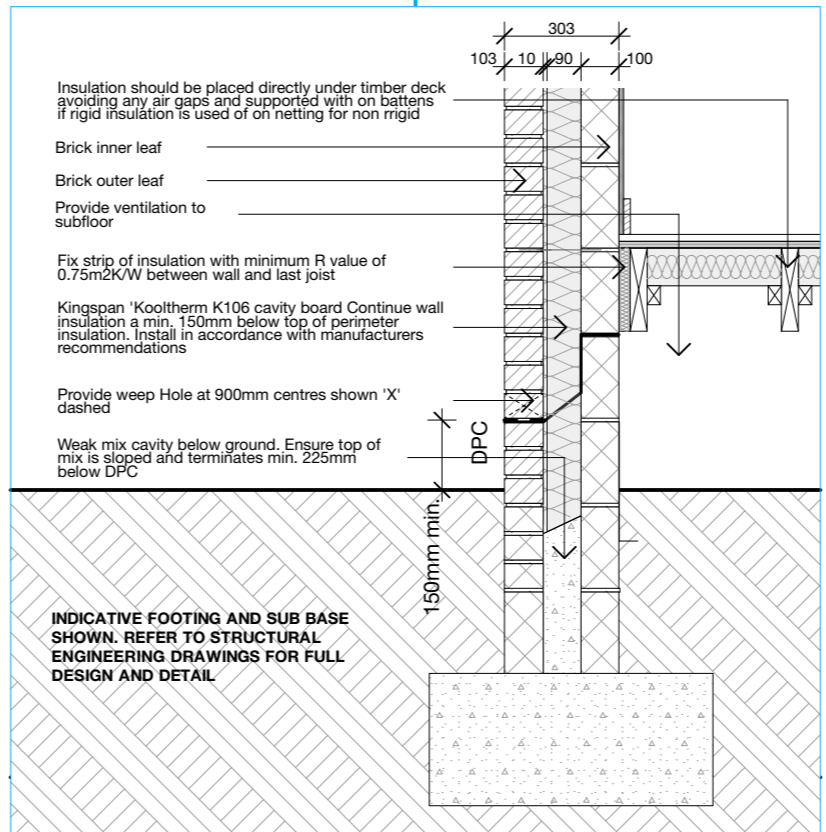
Nominal 50 x 25 mm under batten

12mm Sheathing board

Breather membrane

\*\*\*Important Note\*\*\*

Detail indicates. Install slate cladding in accordance with manufacturers recommendations\*\*\*



Insulation should be placed directly under timber deck avoiding any air gaps and supported with on battens if rigid insulation is used or on netting for non rigid

Brick inner leaf

Brick outer leaf

Provide ventilation to subfloor

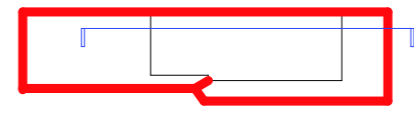
Fix strip of insulation with minimum R value of 0.75m<sup>2</sup>K/W between wall and last joist

Kingspan 'Kooltherm K106 cavity board Continue wall insulation a min. 150mm below top of perimeter insulation. Install in accordance with manufacturers recommendations

Provide weep Hole at 900mm centres shown 'X' dashed

Weak mix cavity below ground. Ensure top of mix is sloped and terminates min. 225mm below DPC

INDICATIVE FOOTING AND SUB BASE SHOWN. REFER TO STRUCTURAL ENGINEERING DRAWINGS FOR FULL DESIGN AND DETAIL



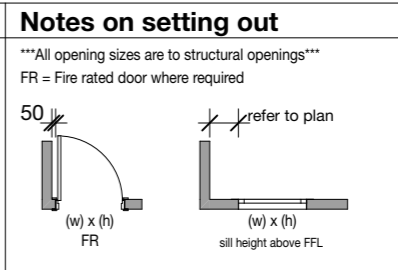
key plan scale 1:500

Legend		Refer to General Notes For Details	
ref.	Refrigerator	st	Store
wo.	Wall oven	wir	Walk in wardrobe
dw	Dishwasher	hc	Hosecock
shr.	Shower	W1	Wall type 1
s	Sink	W2	Wall type 2
t	Laundry tub	PS	plumbing stack
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R1	Roof Type 1	DP	Downpipe
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Drawing Title  
**Sections**

Drawing Number Scale

**TP09 1:100 @ A3**